

ALTERATIONS TO AND NEW OFFICE BUILDING AT 1601 LAFITTE AVE

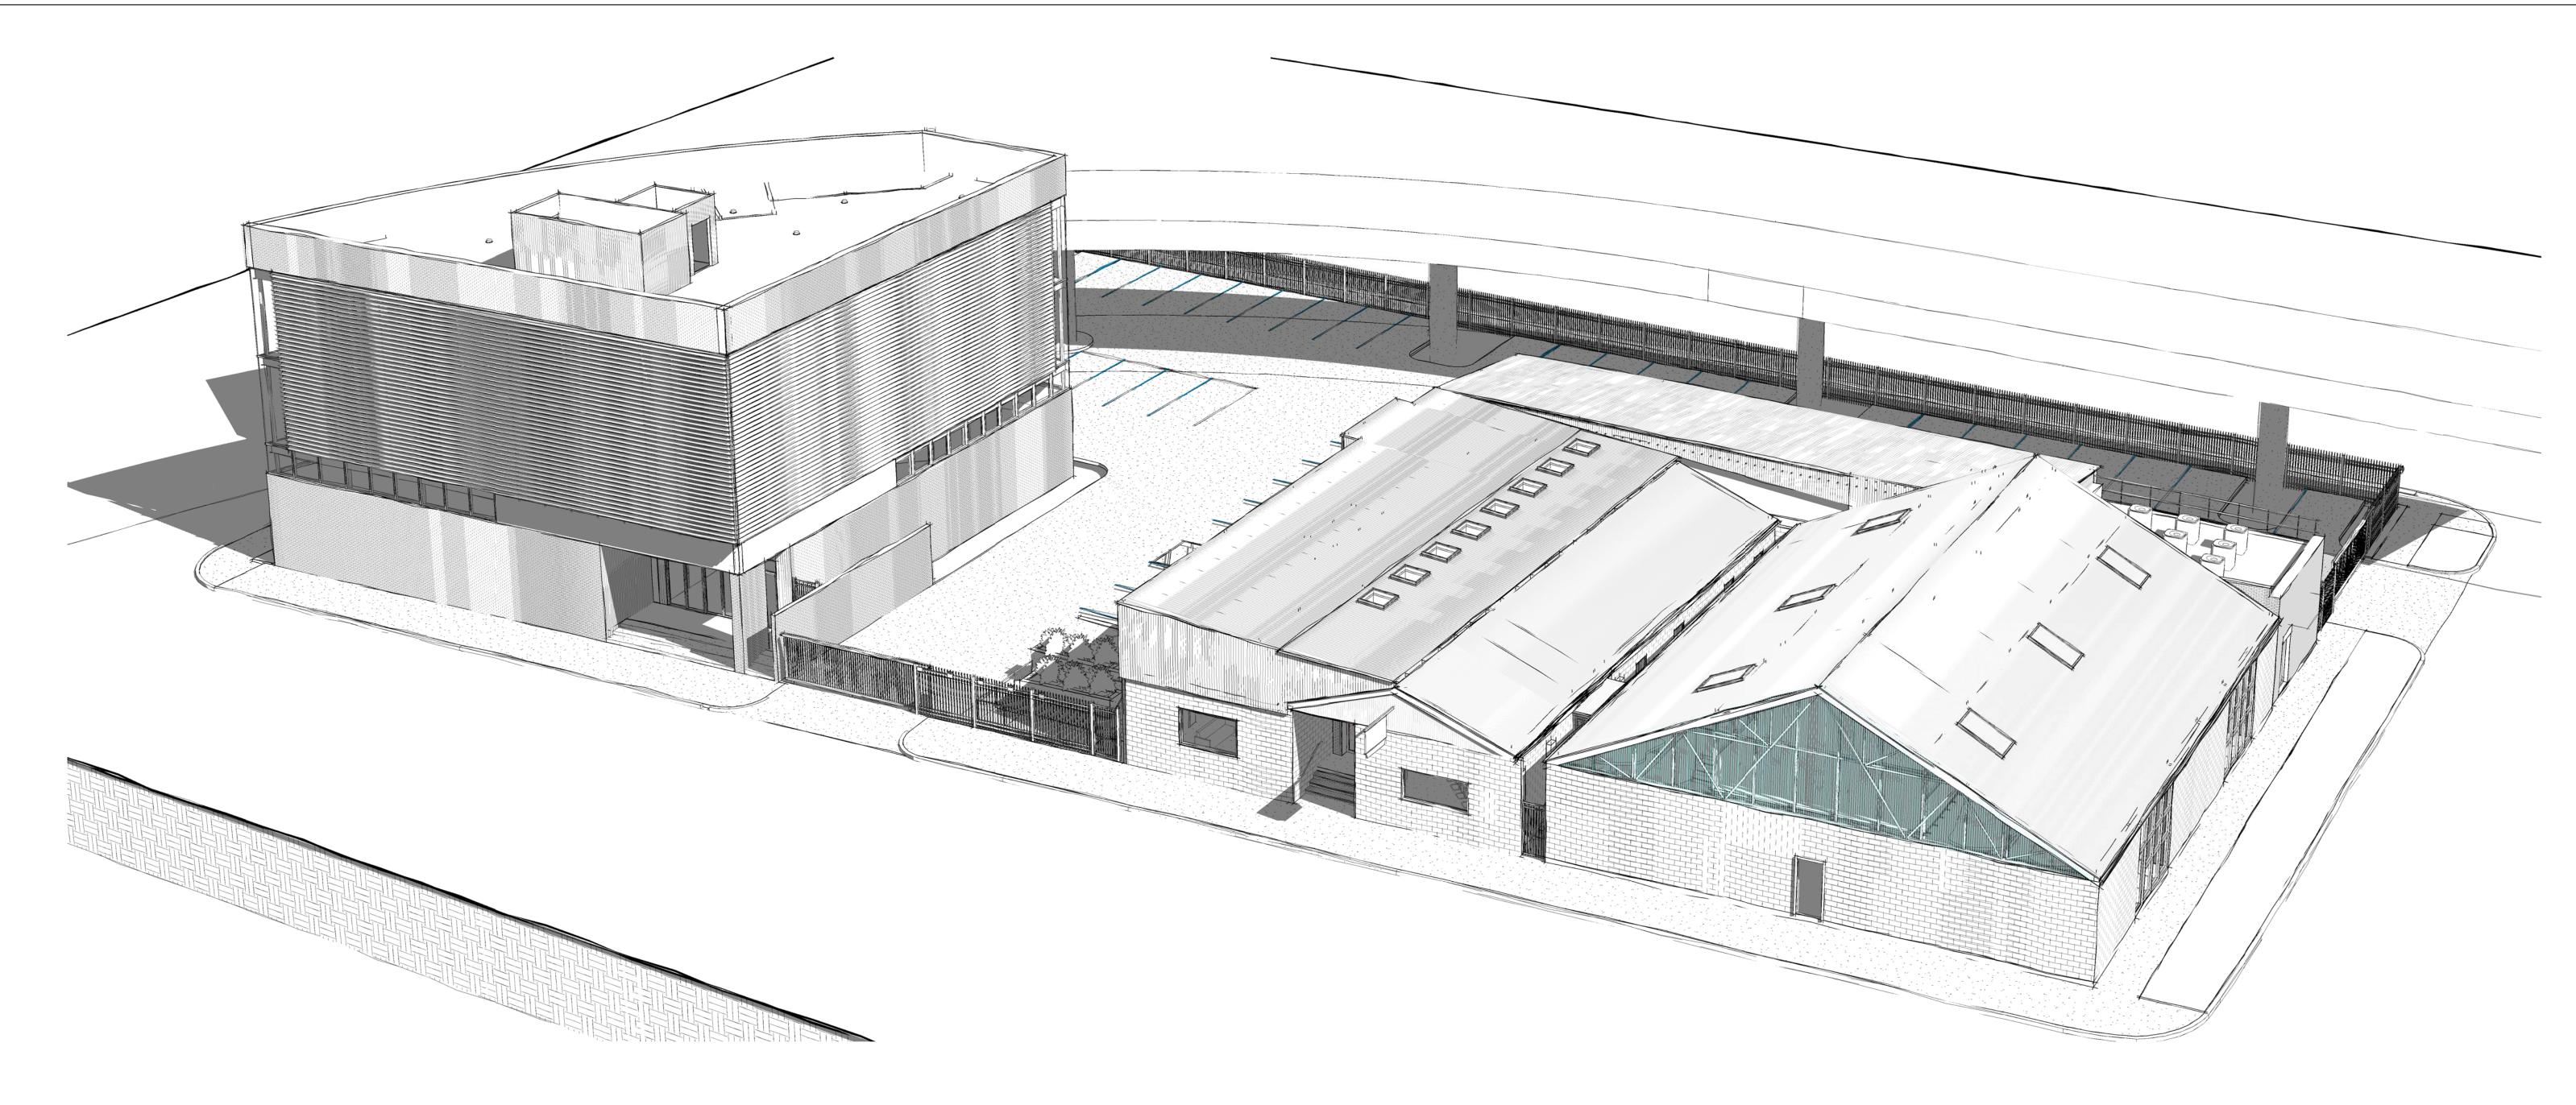

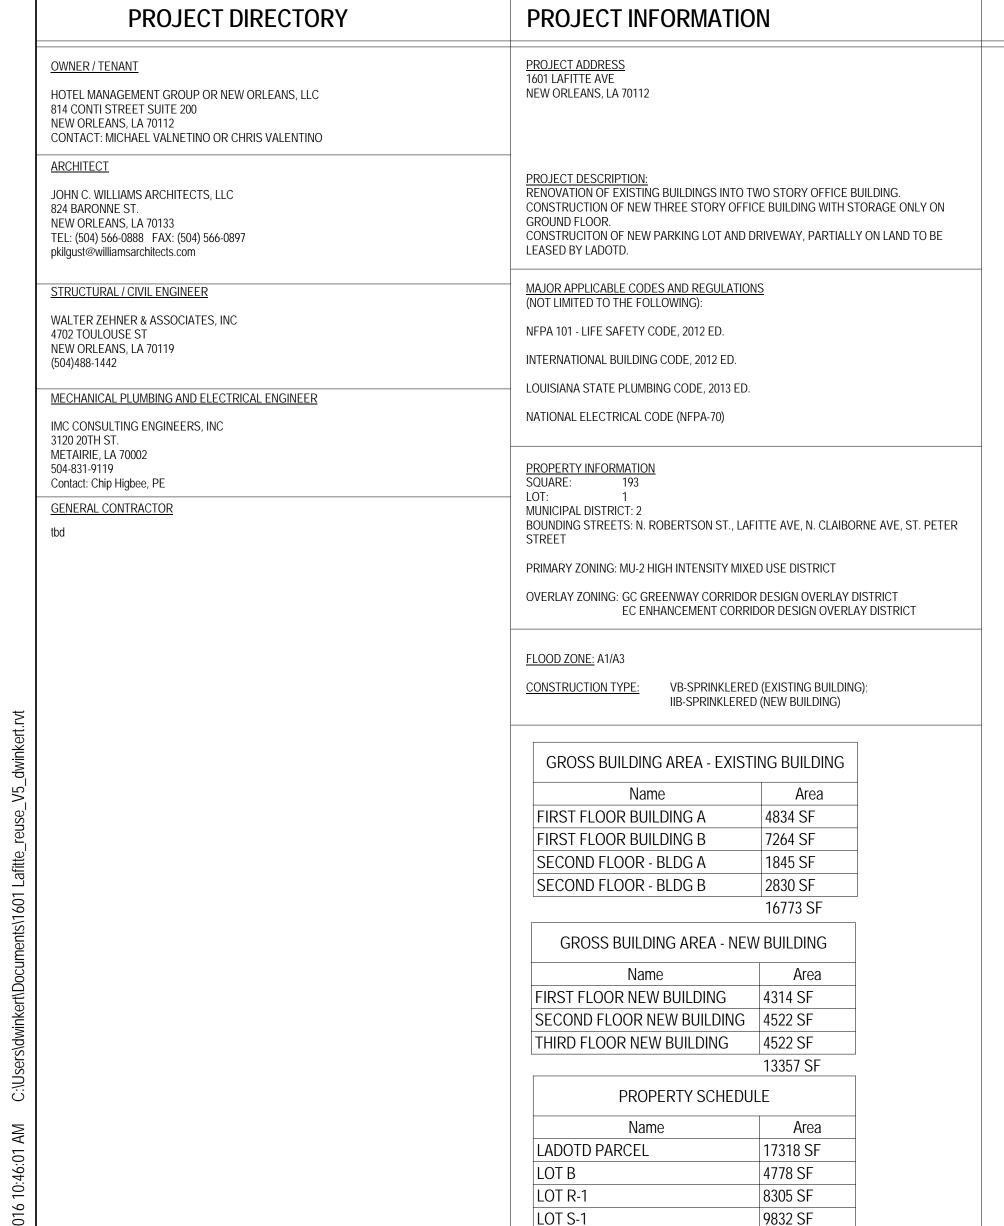

40233 SF

GENERAL NOTES

SEE OTHER SHEETS FOR ADDITIONAL NOTES & SPECIFIC CONSTRUCTION NOTES.

THE GENERAL CONTRACTOR AND SUBCONTRACTORS SHALL VISIT THE PROJECT SITE AND BECOME GENERALLY FAMILIAR WITH THE PROJECT AND WITH THE IMPACT OF THE NEW WORK ON EXISTING CONDITIONS. ANY AREAS OF CONCERN SHALL BE BROUGHT TO THE ATTENTION OF THE ARCHITECT PRIOR TO SUBMITTING A PROPOSAL. NO ADDITIONAL CHARGE TO THE OWNER WILL BE APPROVED WHICH IS ATTRIBUTABLE TO THE CONTRACTOR'S FAILURE TO MEET THIS REQUIREMENT.

WORK ONLY FROM THE WRITTEN DIMENSIONS SHOWN. DO NOT SCALE DRAWINGS. DETAIL

DIMENSIONS TAKE PRECEDENCE OVER PLAN DIMENSIONS. THE GENERAL CONTRACTOR SHALL FIELD VERIFY ALL CONDITIONS, INCLUDING STRUCTURAL, AND

DIMENSIONS PRIOR TO CONSTRUCTION. REPORT DEVIATIONS FROM THE DRAWINGS TO THE ARCHITECT THE GENERAL CONTRACTOR SHALL KEEP THE CONSTRUCTION AREA CLEAN AND SAFE AND PROTECT

ADJACENT AREAS OUTSIDE THE WORK AREA FROM THE WORK OF THIS CONTRACT. REMOVE AND LEGALLY DISPOSE OF DEBRIS, RUBBISH AND OTHER MATERIALS RESULTING FROM CONSTRUCTION OPERATIONS. THE GENERAL CONTRACTOR IS FULLY RESPONSIBLE FOR THE CONSTRUCTION, MATERIALS AND WORKMANSHIP OF THE PROJECT DESCRIBED IN THESE DRAWINGS AND NOTES, AND IS TO COMPLY WITH THE INTENT AS WELL AS THE LETTER IN WHICH THEY WERE WRITTEN.

THE GENERAL CONTRACTOR SHALL PROVIDE ALL NECESSARY PROTECTION FOR HIS WORK UNTIL TURNED OVER TO THE OWNER.

THE GENERAL CONTRACTOR IS RESPONSIBLE FOR COORDINATION WITH HIS SUBCONTRACTORS. ANY CONFLICTS WITH THEIR WORK, EQUIPMENT PLACEMENT, ETC. ARE TO BE RESOLVED PRIOR TO INSTALLATION A) THE CONTRACTOR SHALL COORDINATE AND LOCATE ELECTRICAL DEVICES, DATA AND PHONE RECEPTACLES, SWITCHES, ETC. TO AVOID CONFLICTS WITH CASEWORK, DOORS AND OTHER TRADES. B) THE CONTRACTOR SHALL VERIFY & COORDINATE, WITH ALL TRADES, THE SIZES AND LOCATIONS OF ALL OPENINGS FOR MECHANICAL, PLUMBING AND ELECTRICAL EQUIPMENT, EQUIPMENT PADS, OR BASES AS WELL AS POWER, WATER AND DRAIN INSTALLATIONS BEFORE PROCEEDING WITH THE THE CONTRACTOR SHALL PROVIDE COORDINATION DRAWINGS FOR PROPER PLACEMENT OF ALL TRADES WORK. ALL CONCERNS, SPACE LIMITATIONS OR STRUCTURAL CONFLICTS SHALL BE BROUGHT

CONTRACTOR SHALL SUBMIT SHOP DRAWINGS FOR ALL CASEWORK, MILLWORK AND SPECIALTY ITEMS TO ARCHITECT FOR REVIEW PRIOR TO FABRICATION.

MANUFACTURER'S RECOMMENDED SPECIFICATIONS. LOCATION AND DIMENSIONS SHALL BE PER ARCHITECTURAL DRAWINGS. DISCREPANCIES MUST BE BROUGHT TO THE ATTENTION OF THE ARCHITECT BEFORE THE START OF WORK. FURNISHINGS INDICATED ON

ARE FOR REFERENCE AND COORDINATION. I. VARIATIONS FROM THE WORK DUE TO AVAILABILITY OF MATERIALS, FIELD CONDITIONS, EQUIPMENT SPECS, ETC. SHALL BE MADE ONLY WITH THE APPROVAL OF THE ARCHITECT.

INSTALL ALL MANUFACTURED ITEMS, MATERIALS AND EQUIPMENT IN STRICT ACCORDANCE WITH

12. ALL WORK SHALL BE PERFORMED IN COMPLETE COMPLIANCE WITH ALL NATIONAL, STATE AND LOCAL CODES AND ORDINANCES AND IN ACCORDANCE WITH THE AGENCIES HAVING JURISDICTION. THE CONTRACTOR SHALL OBTAIN ALL NECESSARY PERMITS AND INSPECTIONS FOR THE WORK. 13. IT IS THE INTENT OF THE DOCUMENTS TO PROVIDE FOR COMPLETE FINISHED WORK. ALL

MISCELLANEOUS COMPONENTS, PARTS, ANCHORS, AND OTHER INCIDENTAL ITEMS REQUIRED FOR COMPLETE ASSEMBLY, FUNCTIONING AND OPERATION OF AN ITEM OR SYSTEM SHALL BE PROVIDED. THE CONTRACTOR SHALL INCLUDE ALL COMPONENTS THAT ARE NORMALLY INCIDENTAL TO THE WORK. THOSE COMPONENTS WHICH ARE NOT SHOWN ON THE DRAWINGS OR CALLED FOR IN THE SPECIFICATION, BUT WHICH ARE REQUIRED AS ESSENTIAL AESTHETICS OR FUNCTIONAL COMPONENT OF THE WORK, SHALL BE INCLUDED AS IF IT WERE DRAWN OR SPECIFIED.

14. IT IS THE RESPONSIBILITY OF THE GENERAL CONTRACTOR TO PROVIDE IN A TIMELY MANNER, AT NO ADDITIONAL COST TO THE OWNER, ACCURATE AND COMPLETE DRAWINGS, SKETCHES, AND PHOTOGRAPHS

SUFFICIENT TO CLEARLY DESCRIBE DISCREPANCIES, CONFLICTS AND CONCEALED OR OTHERWISE UNANTICIPATED EXISTING CONDITIONS ENCOUNTERED THAT AFFECT THE NEW CONSTRUCTION. 15. APPLY FOR AND SECURE ALL PERMITS AND COMPLY WITH ALL APPLICABLE CODES AND REGULATIONS FOR SAFETY AND PROTECTION OF ADJACENT BUILDINGS AND OCCUPIED AREAS, DUST CONTROL, UTILITY DISCOVERED HAZARDS AND DISPOSAL. CONTACT APPROPRIATE AGENCIES PRIOR TO ANY BELOW GRADE EXCAVATIONS. NOTIFY OWNER AND PROTECT FROM DISTURBANCE ANY DISCOVERY OF SUSPECTED

EXISTING CONDITIONS INDICATED ARE APPROXIMATE AND SHALL BE FIELD VERIFIED BY THE CONTRACTOR PRIOR TO PROCEEDING WITH ANY WORK. IF CONDITIONS VARY GREATLY FROM THOSE SHOWN, THE CONTRACTOR SHALL NOTIFY THE ARCHITECT BEFORE PROCEEDING WITH WORK.

PROTECT ADJACENT PROPERTY AND PERSONS FROM THE WORK. WORKING OUTSIDE THE

DO NOT BLOCK DRIVEWAYS, FIRE EXITS AND FIRE EXIT ROUTES LIMIT NOISE TO NORMAL CONSTRUCTION OPERATIONS.

DESIGNATED LIMITS IS PROHIBITED UNLESS APPROVED BY THE CLIENT/USER.

TO ESTABLISH THE COMPLETE SCOPE OF ITS WORK AND TO AFFECT CLOSE COORDINATION WITH THE OTHER TRADES, EACH TRADE SHALL VISIT THESITE AND COMPLETELY REVIEW THE DRAWINGS NOT ONLY FOR ITS RESPECTIVE TRADE, BUT THE WORK OF OTHER RELATED TRADES AS

AND BUILDING AND TO VERIFY MINIMUM CLEARANCES AVAILABLE FOR USE IN TRANSPORTING NECESSARY CONSTRUCTION MACHINERY, EQUIPMENT, MATERIALS AND COMPONENTS INTO THE BUILDING AND ON THE SITE. THE CONTRACTOR SHALL PROTECT EXISTING UTILITIES AND SERVICES AGAINST

19. IT IS THE RESPONSIBILITY OF THE CONTRACTOR TO IDENTIFY POINTS OF ACCESS TO THE SITE

INTERRUPTION DUE TO THIS WORK. NECESSARY DISRUPTIONS MUST BE COORDINATED IN ADVANCE OF 21. VERIFY PROPERTY LINES, CONDITIONS, SERVICES AND DIMENSIONS BEFORE COMMENCING

KEEP THE CONSTRUCTION AREA CLEAN AND SAFE AND PROTECT ADJACENT AREAS OUTSIDE THE WORK AREA FROM CONSTRUCTION ACTIVITIES, AND PROVIDE ALL NECESSARY PROTECTION OF THIS OWN WORK UNTIL TURNED OVER TO THE OWNER.

PROVIDE A MINIMUM, 6' HIGH FENCING AND METAL POSTS FOR PROTECTION OF AREAS DURING OPERATIONS AND FOR SECURITY CONTROL. PROVIDE OTHER PEDESTRIAN AND PUBLIC PROTECTION REQUIRED BY THE REGULATORY AGENCIES.

PROVIDE INTERIOR AND EXTERIOR BRACING OR SUPPORT TO PREVENT MOVEMENT, SETTLEMENT, OR COLLAPSE OF AREA BEING WORKED IN AND ADJACENT AREAS. CEASE OPERATIONS AND NOTIFY ARCHITECT IMMEDIATELY IF SAFETY OF STRUCTURE APPEARS TO BE ENDANGERED. TAKE PRECAUTIONS TO SUPPORT STRUCTURE UNTIL DETERMINATION IS MADE TO CONTINUE OPERATIONS. 25. PROVIDE SECURITY AND FACILITIES TO PROTECT SITE AREA, EXISTING FACILITY AND EQUIPMENT FROM UNAUTHORIZED ENTRY, VANDALISM OR THEFT DURING THE WORK. CONTRACTOR

26. CONTRACTOR SHALL HAVE USE OF THE ADJACENT PARKING LOT. THE COST FOR CONNECTION TO AND POWER LINES FROM AVAILABLE POWER SOURCE SHALL

SHALL BE SOLELY RESPONSIBLE FOR THE SECURITY OF HIS/HER OWN EQUIPMENT AND TOOLS.


BE AT CONTRACTOR'S SOLE EXPENSE.

28. PROVIDE TEMPORARY LIGHTING AS REQUIRED; CONNECT TO TEMPORARY ELECTRIC SERVICE. 29. PROVIDE TEMPORARY VENTILATION AS REQUIRED TO PROTECT WORKERS. 30. PROVIDE AND PAY FOR TELEPHONE AND TELEPHONE FACSIMILE SERVICE TO FIELD OFFICE.

CONNECT TO EXISTING WATER SOURCE FOR TEMPORARY WATER SERVICE. IF UTILITY IS CAPPED, COORDINATE WITH CLIENT/USER. 32. PROVIDE TEMPORARY SANITARY FACILITIES.


CONTRACTOR SHALL PROVIDE ALL SHORING AND STABILIZING BRACING AS REQUIRED TO PROTECT FROM STRUCTURAL FAILURE OR COLLAPSE.

34. MAINTAIN FIRE SAFETY/CONTROL AT ALL TIMES.

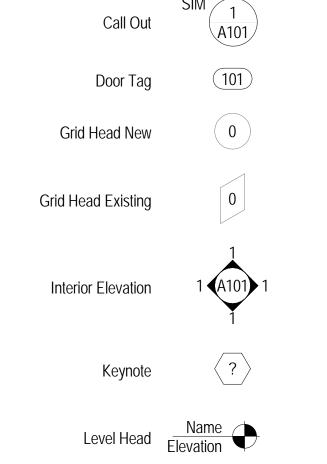

SYMBOL LEGEND

Ĭ	
?	Keynote
Name Elevation	Level Head
Room name 101 10' x 10'	Room Tag
•	

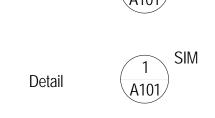

01 EAST ELEVATION BARONNE STREET	1/8" = 1'-0"
View Title	
Wall Tag <u>P1a</u>	

Window Tag (A)

LJIII	I IKST I LOOK LII L SAI LTT FLAN		
03 Civil			
C1.0	CITE DI AM		
C1.0 C2.0	SITE PLAN		
	GRADING PLAN		
C3.0	UTILITY PLAN		
C4.0	EROSION CONTROL PLAN		
C5.0	DETAILS		
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A315	WALL SECTIONS - BLDG B		
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	STOREFRONT SCHEDULE		
A803	STOREFRONT SCHEDULE		
A804	STOREFRONT SCHEDULE		
A811	DOOR DETAILS		
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LIGHTING AND SPECIAL SYSTEM

LIGHTING AND SPECIAL SYSTEM

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NEW BLDG.

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SCHEDULES

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FLOOR - EXISTING BLDG.

FLOOR - EXISTING BLDG.

POWER PLAN FIRST FLOOR -

EXISTING BLDG.

EXISTING BLDG.


A1401 NEW BUILDING STAIR DRAWINGS

A1402 NEW BUILDING STAIR DRAWINGS

A1701 NEW BUILDING FINISH SCHEDULE


A1801 NEW BUILDING DOOR SCHEDULE

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Date	Scope			
DRAWING				
INDEX OF DRAWINGS				
	Date			

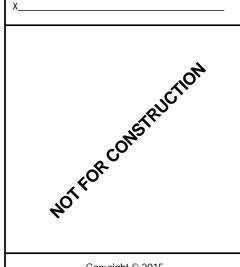JOB No. 515042.00 DATE 4-11-2016 Sheet No.



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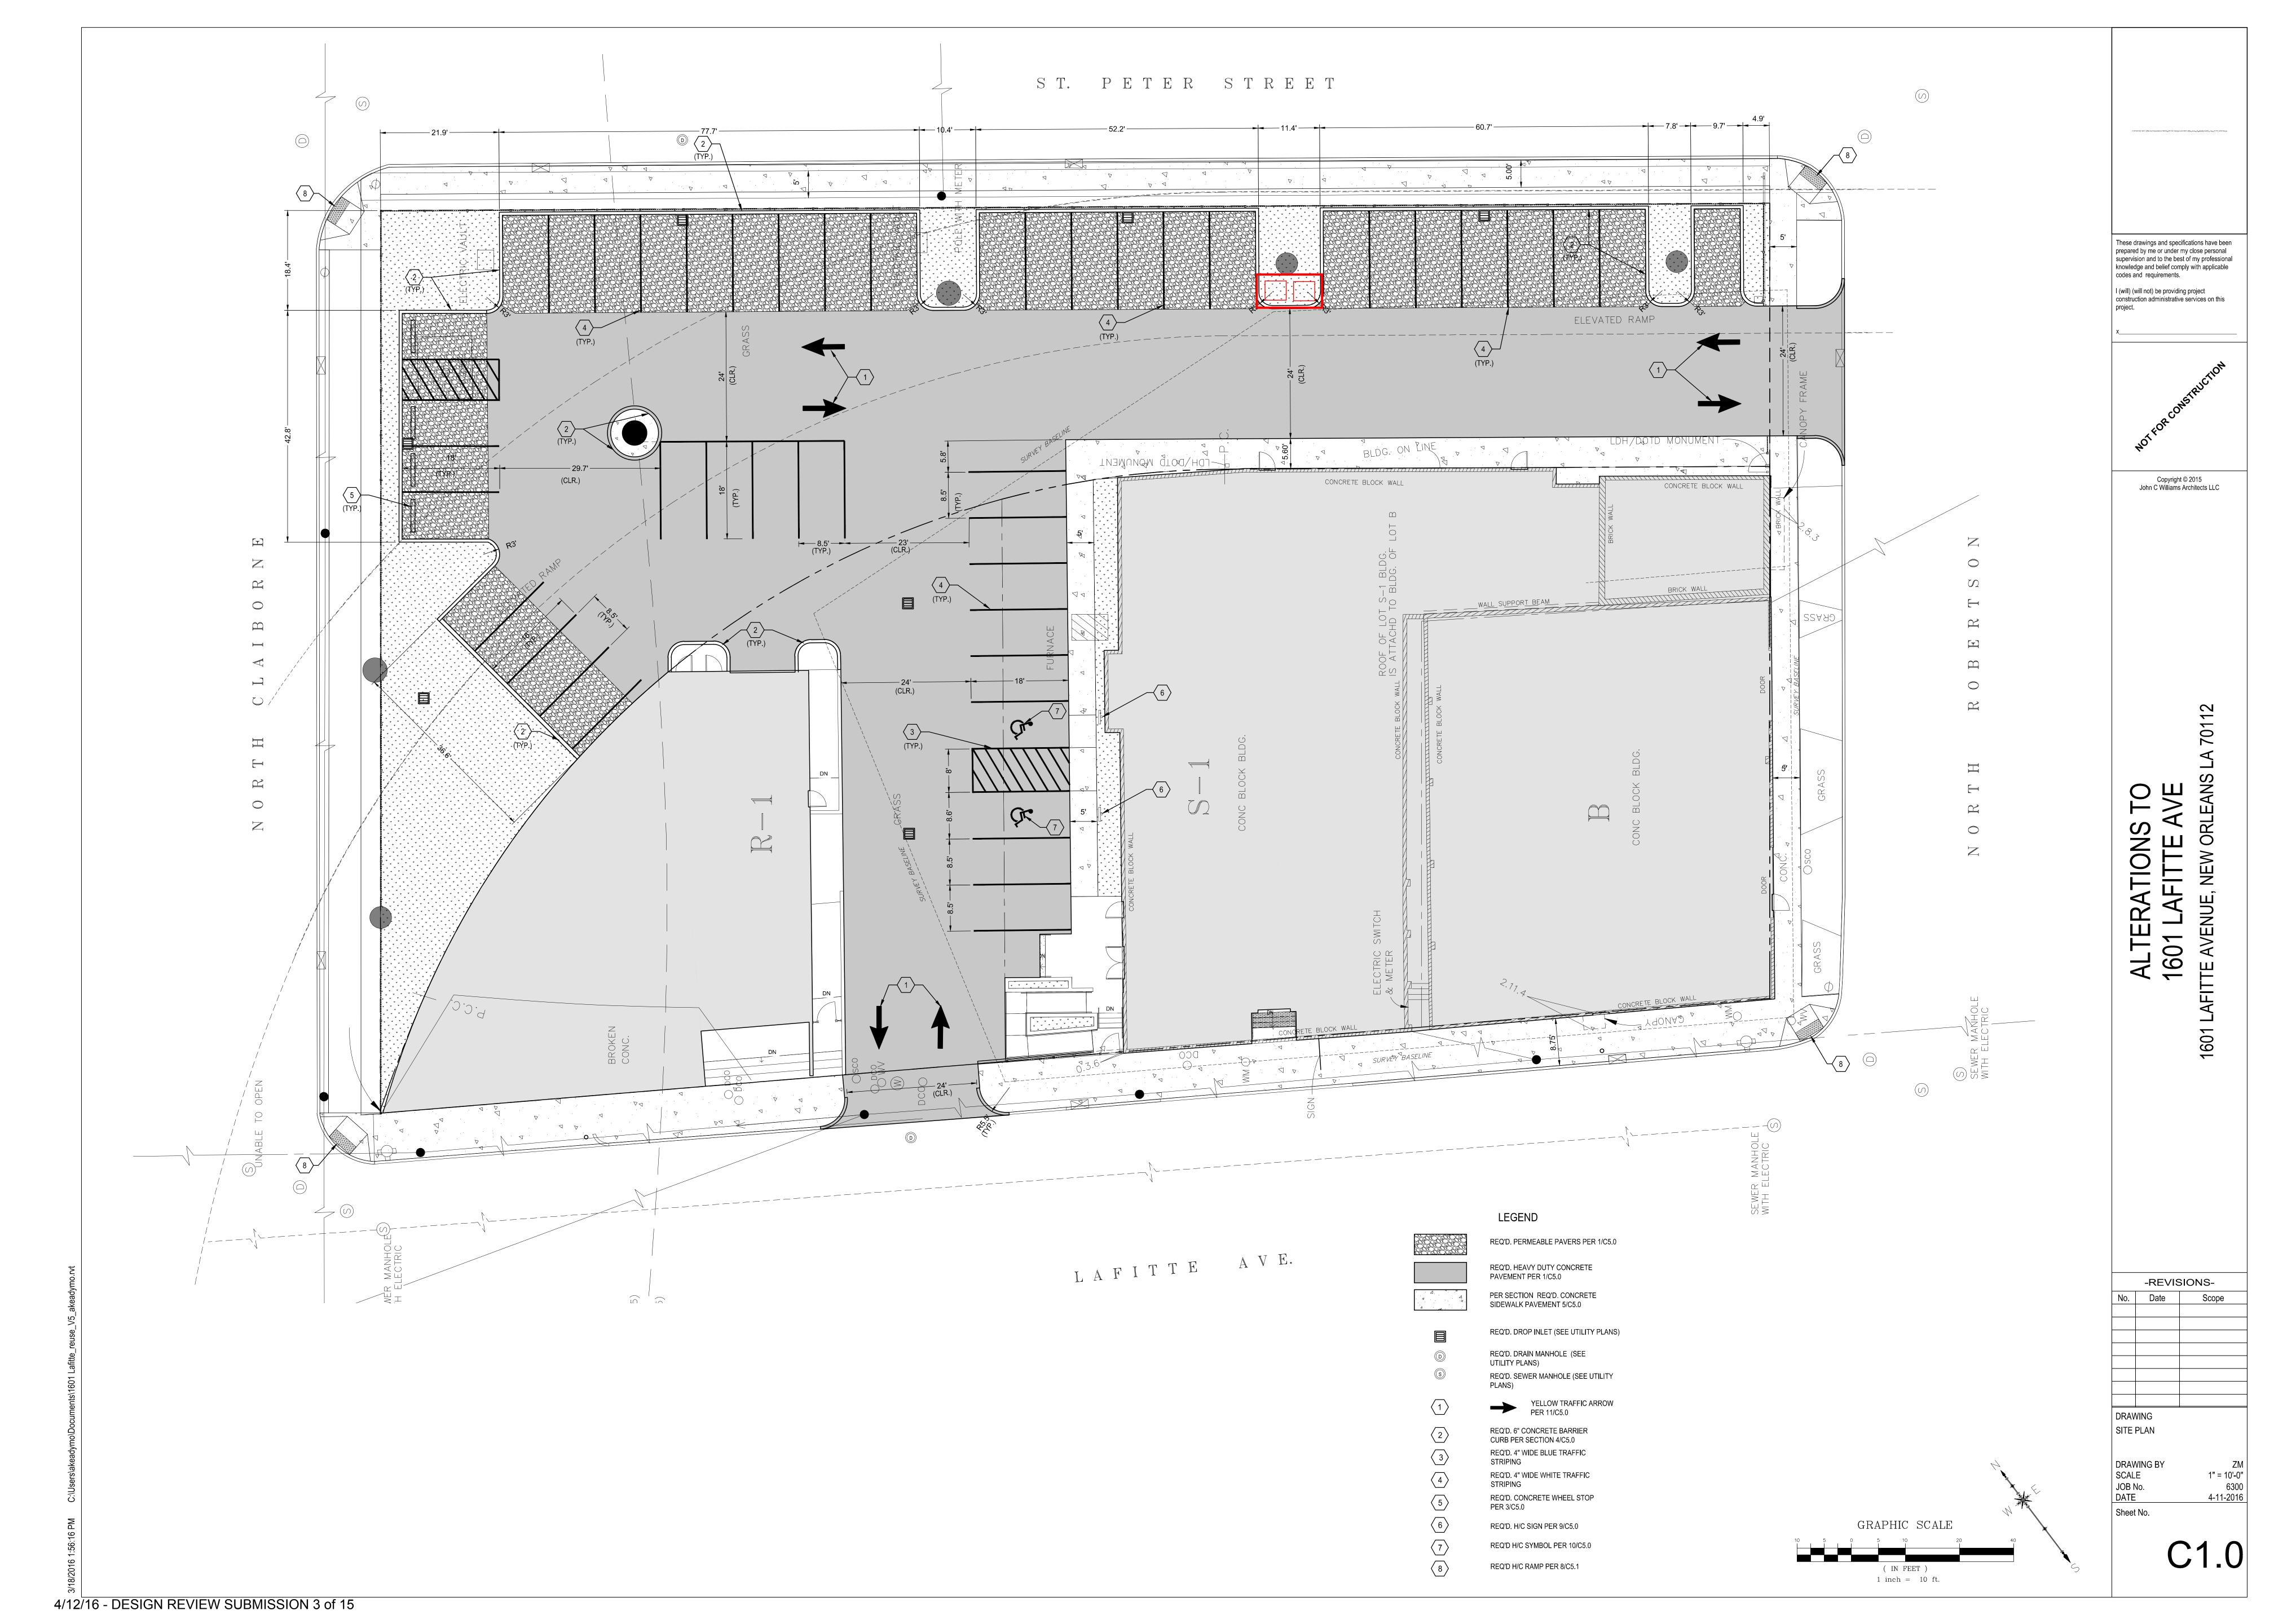
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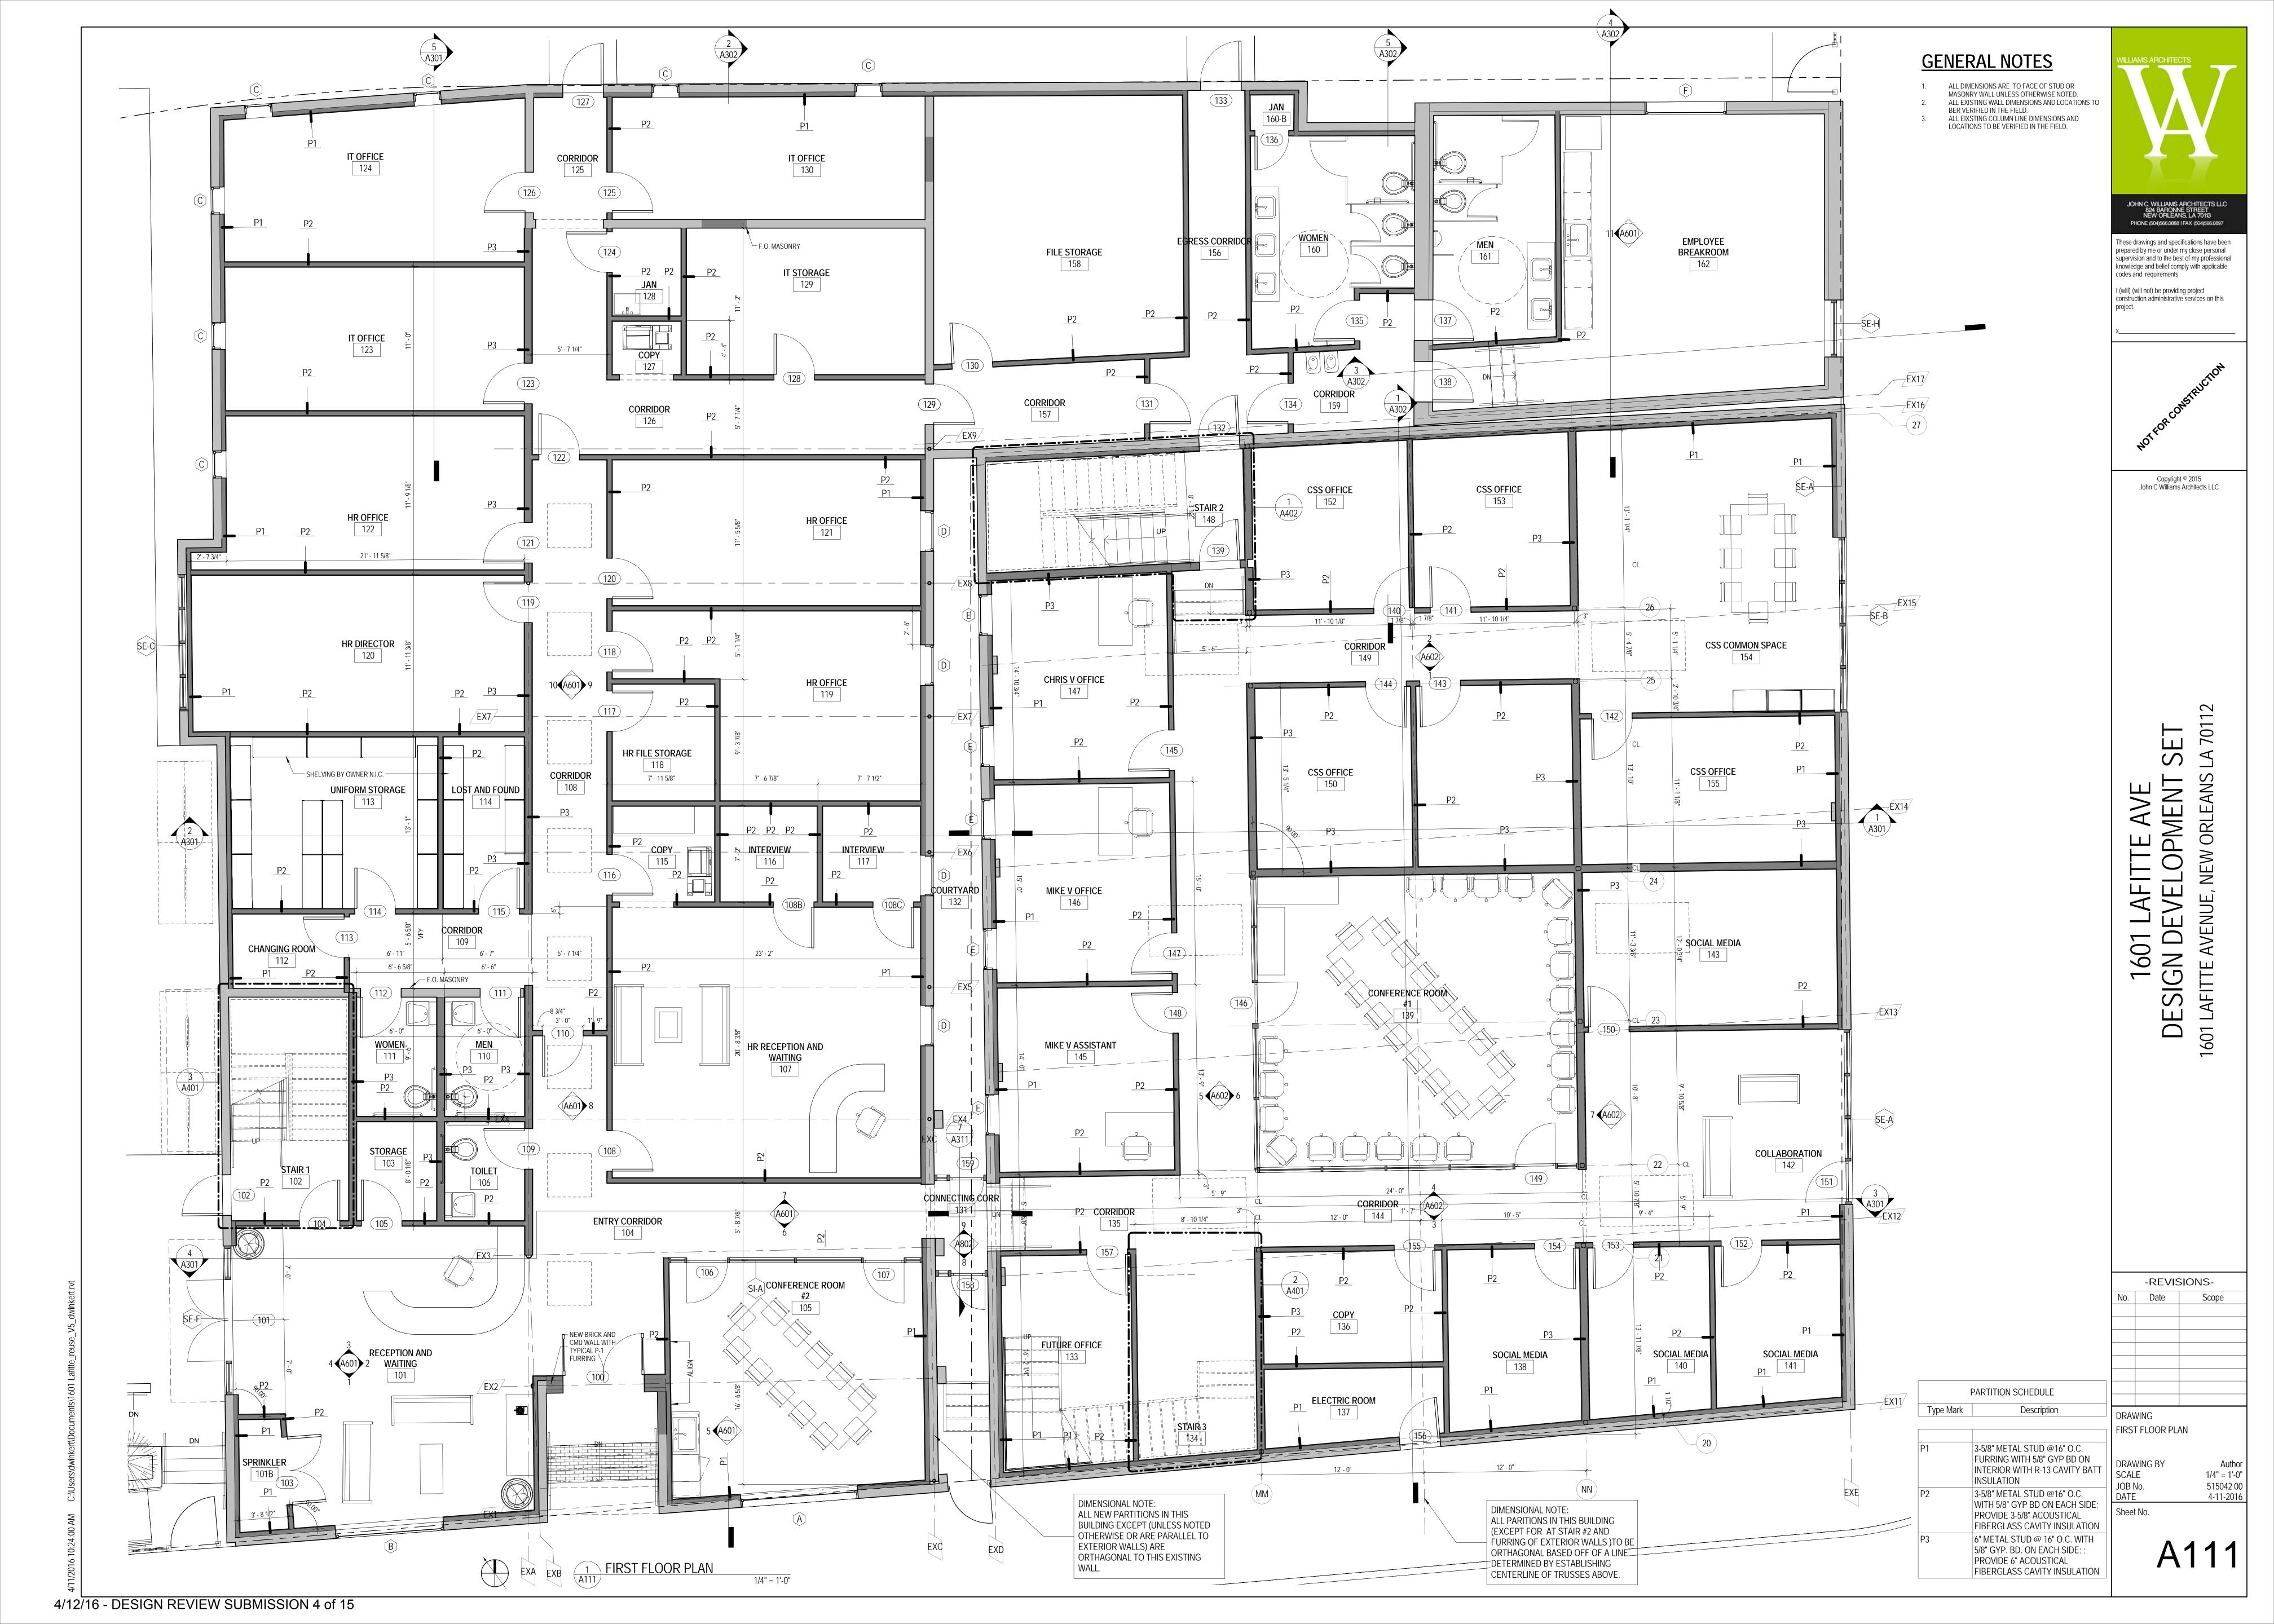
1601 LAFITTE AVE DESIGN DEVELOPMENT
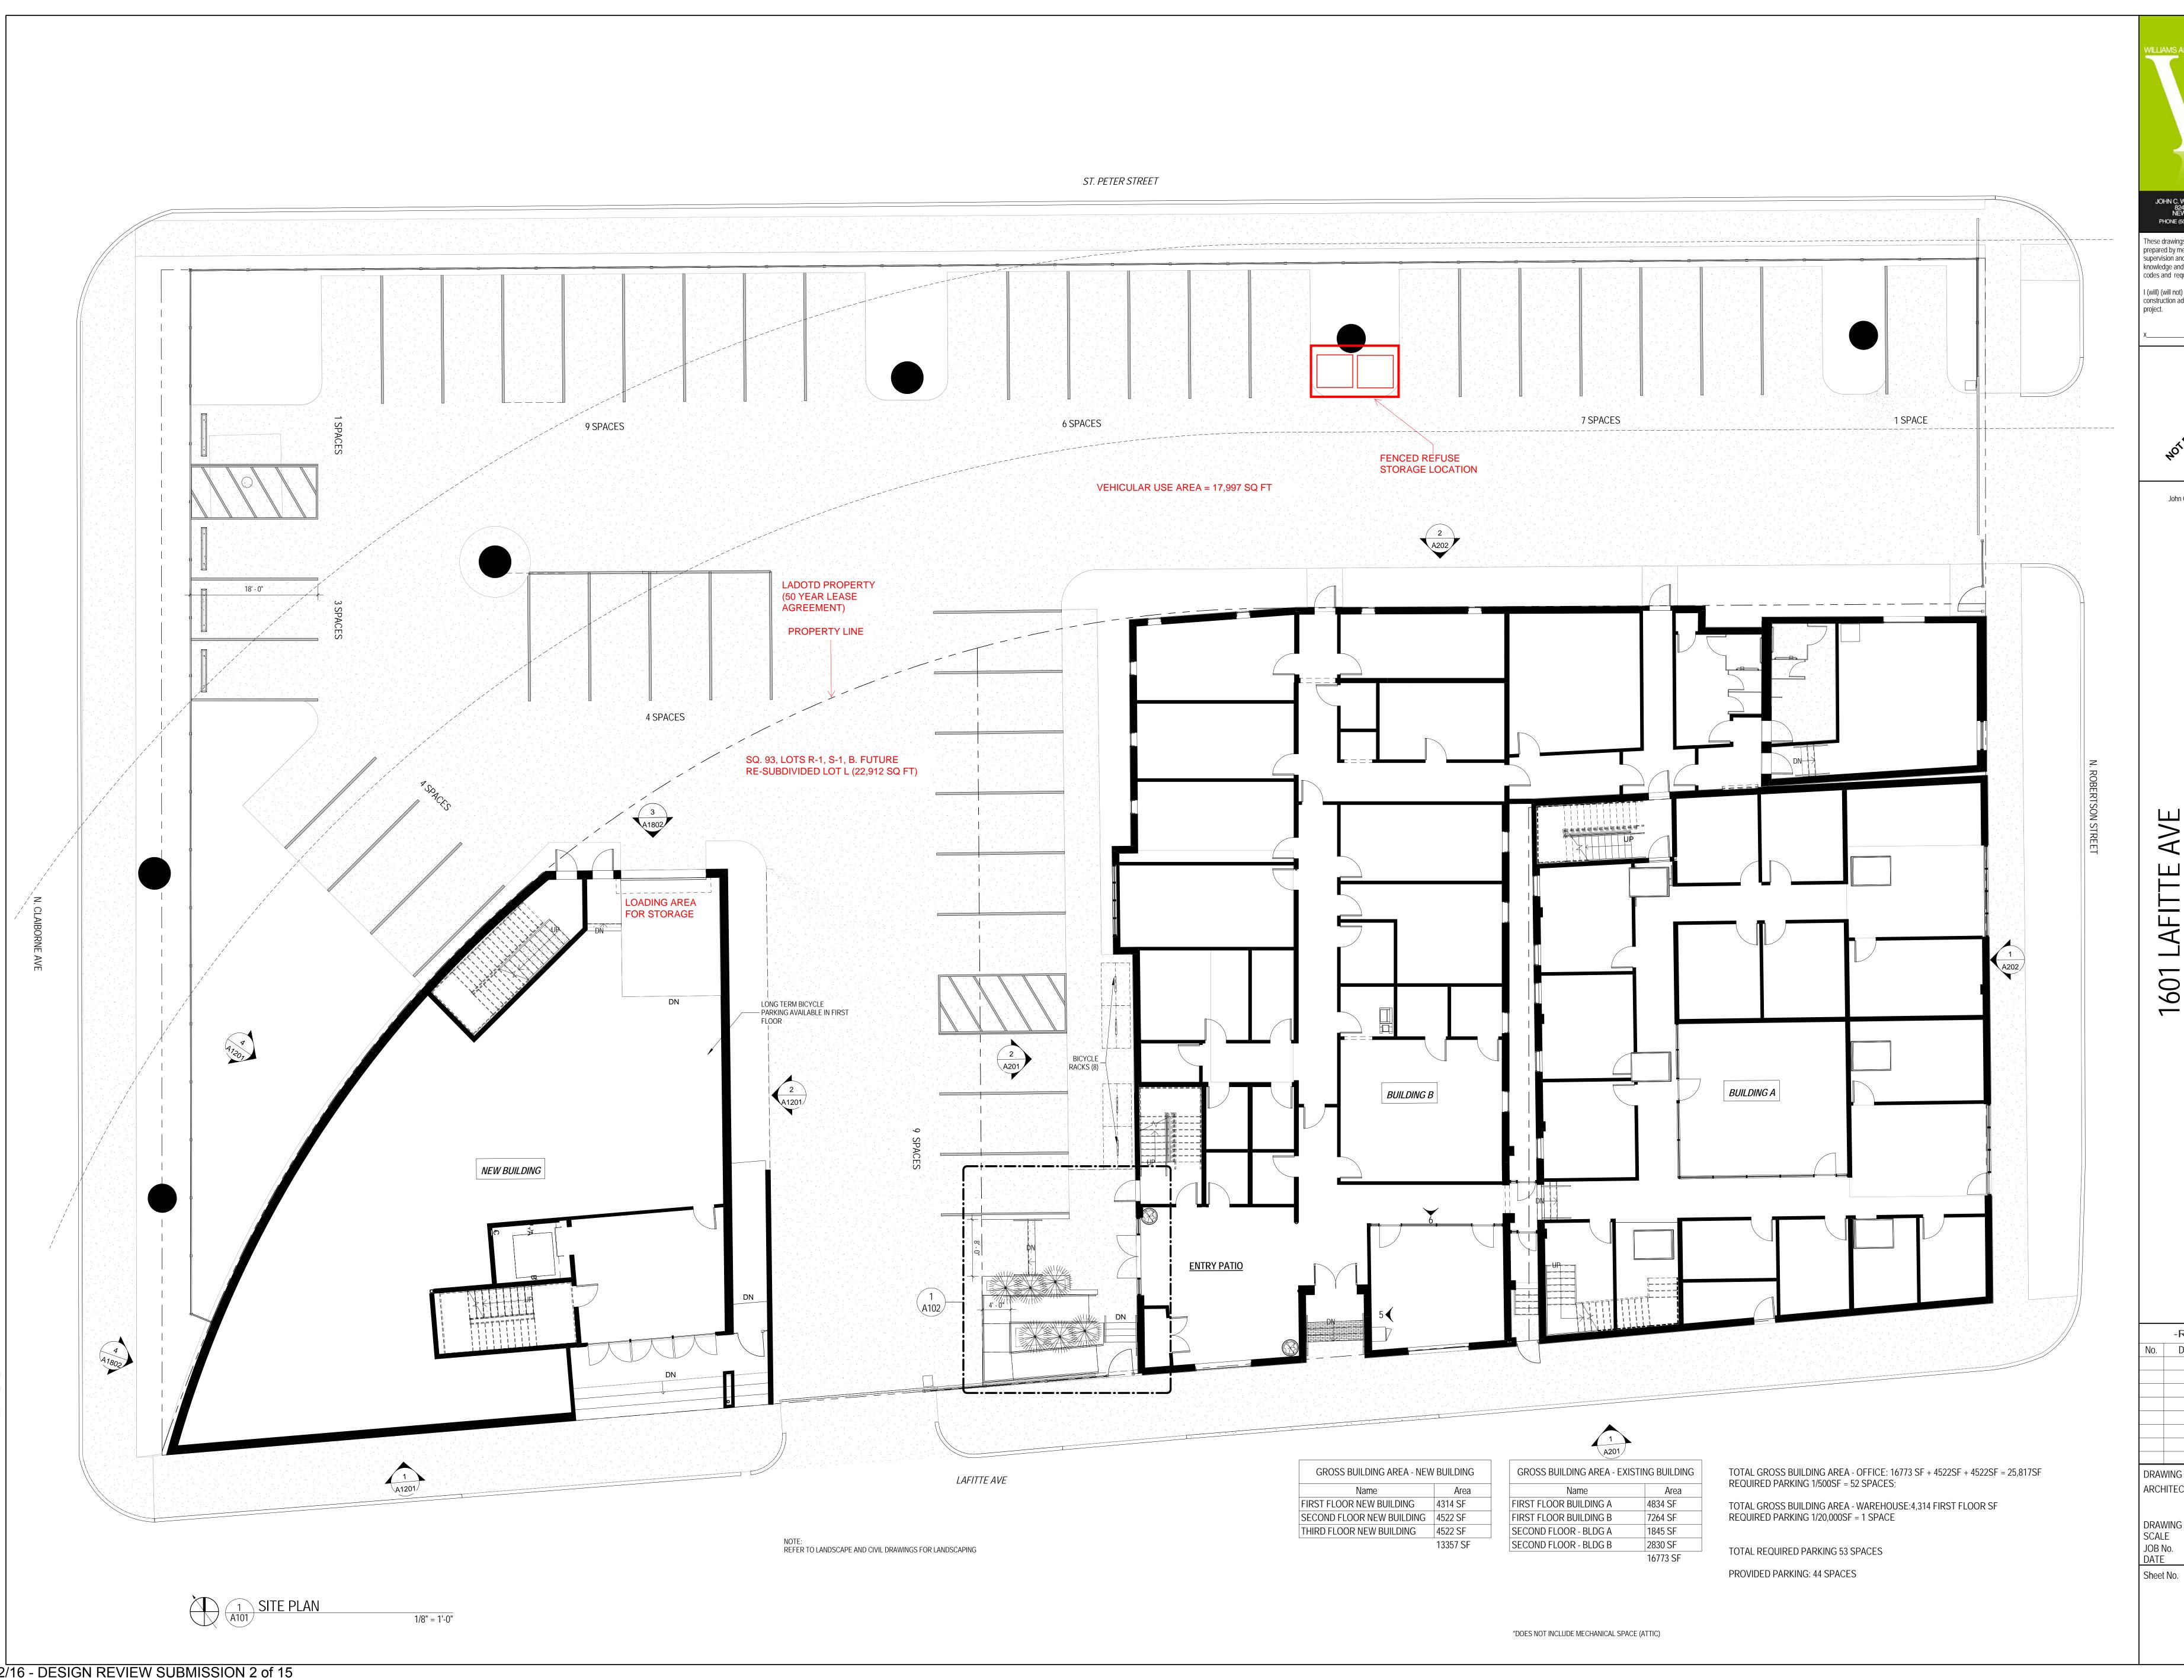
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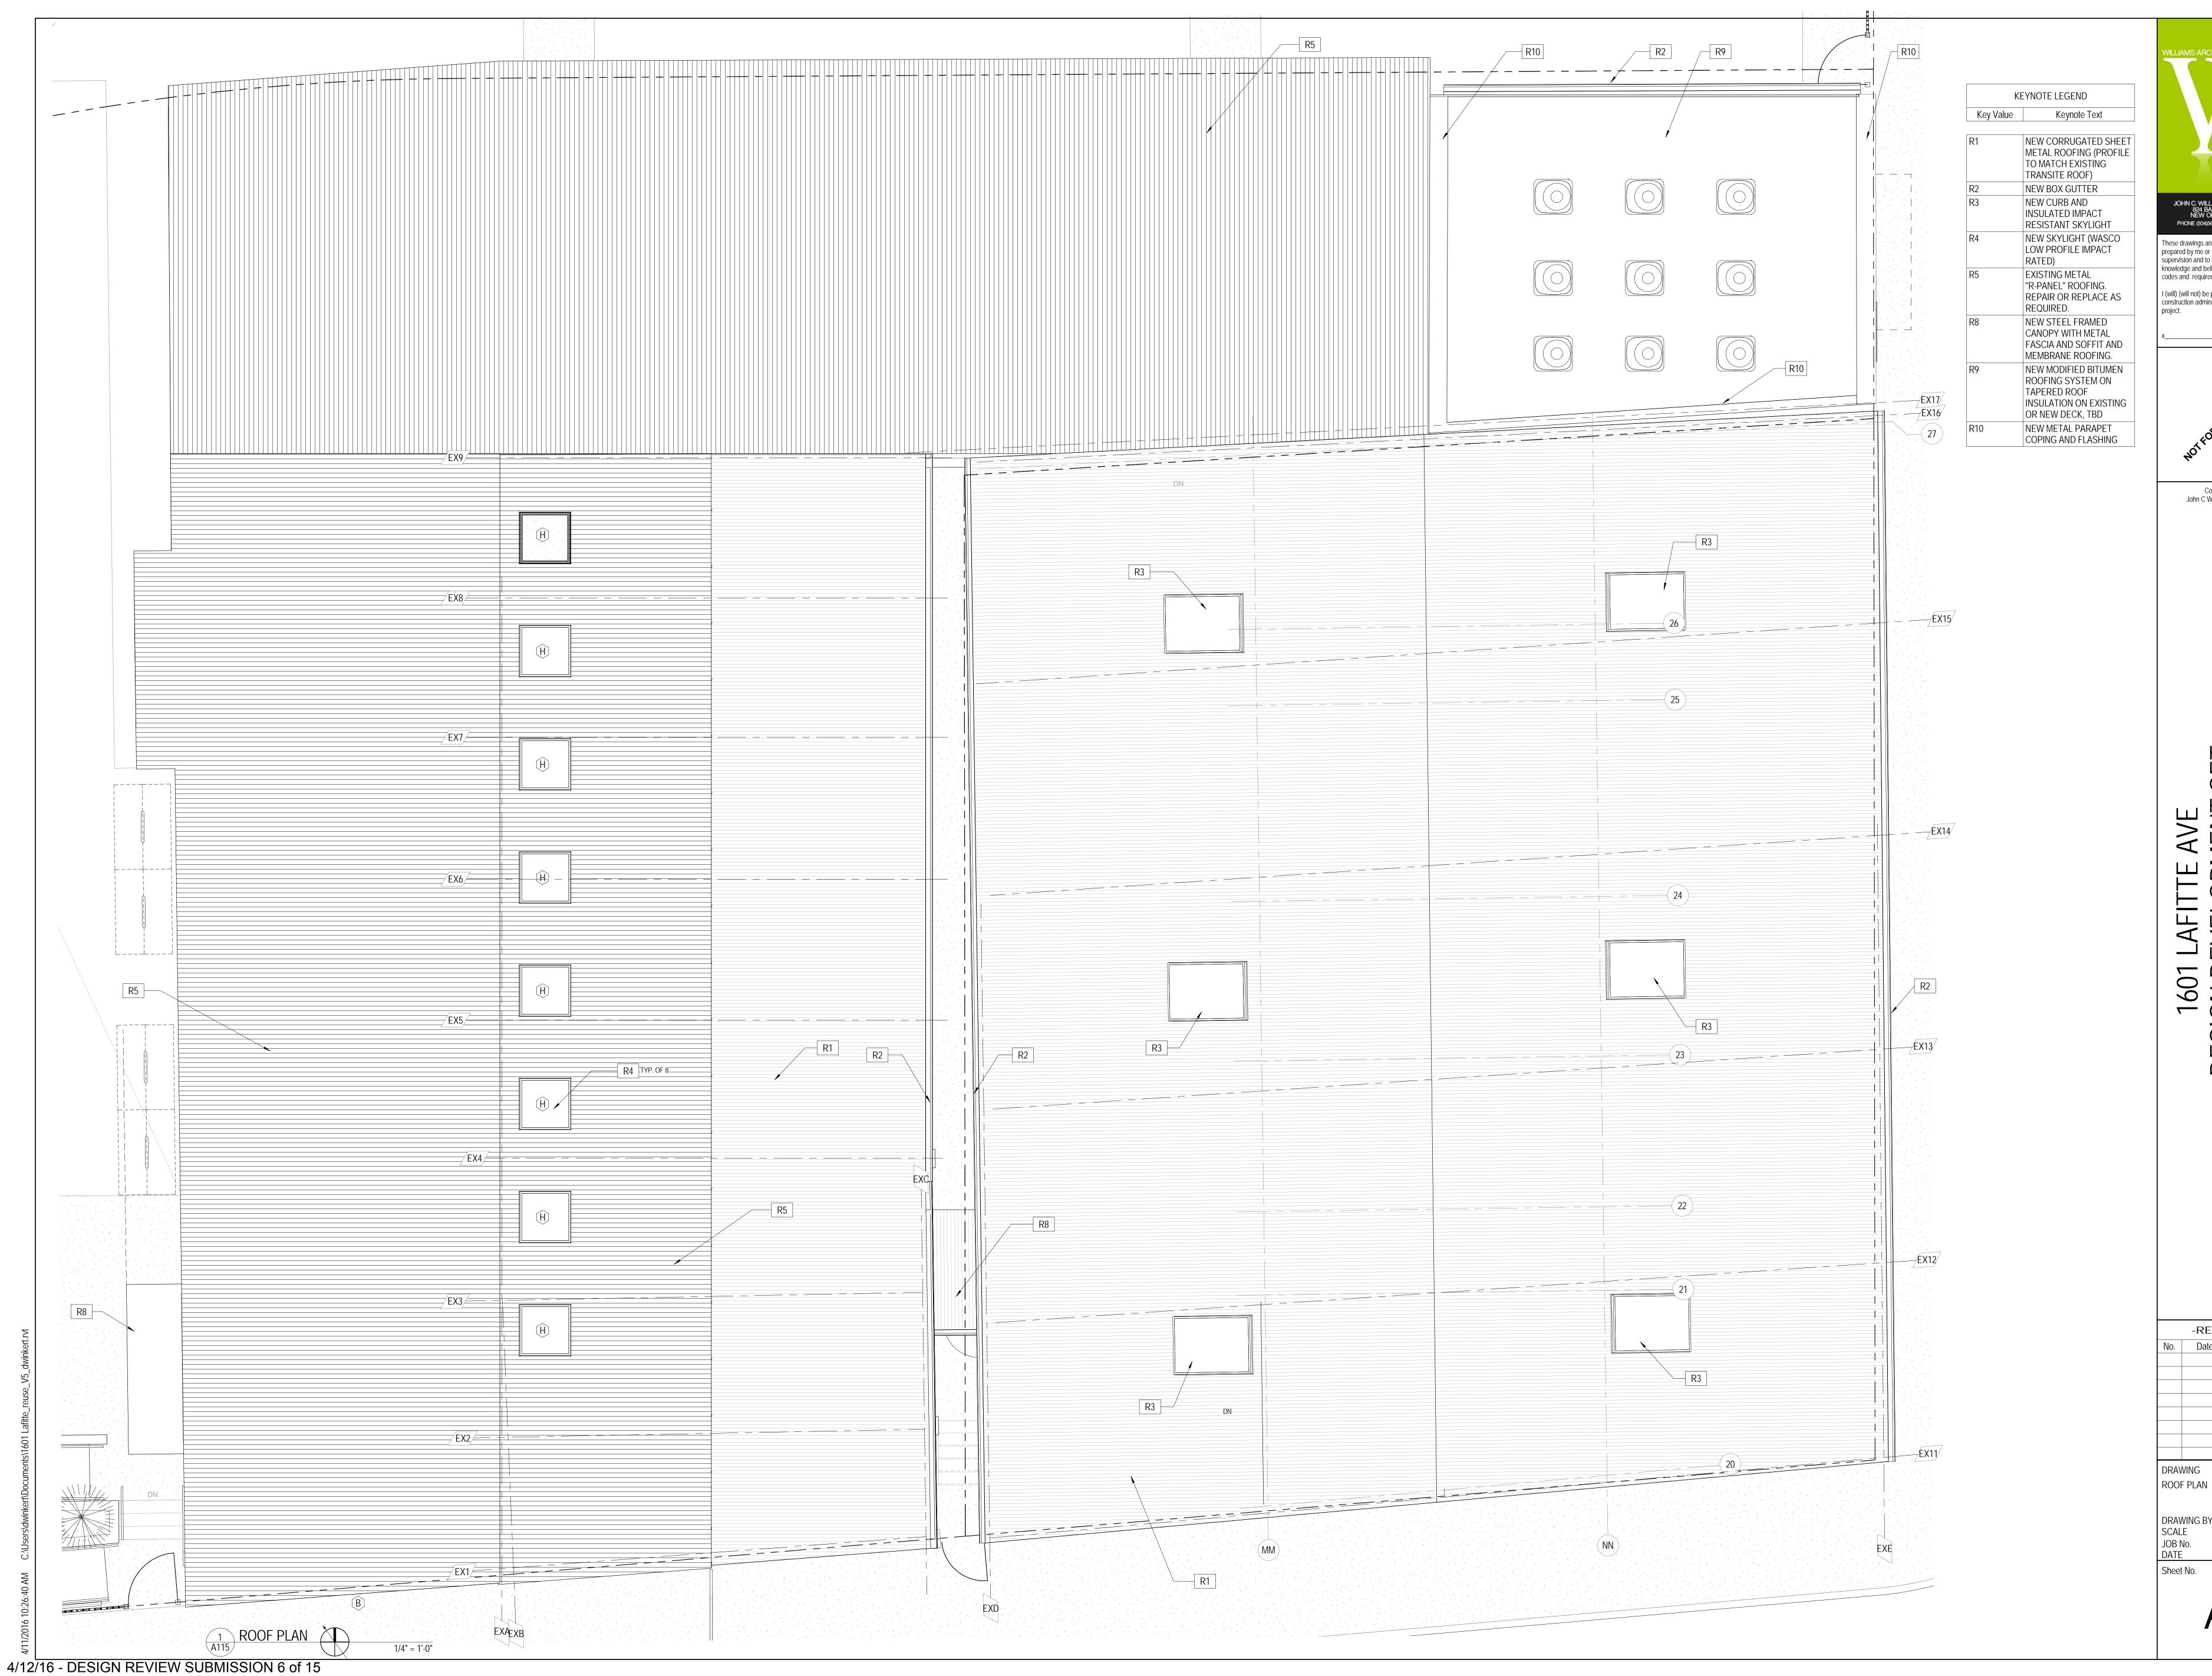
ARCHITECTURAL SITE PLAN

1/8" = 1'-0" JOB No. DATE 515042.00 4-11-2016









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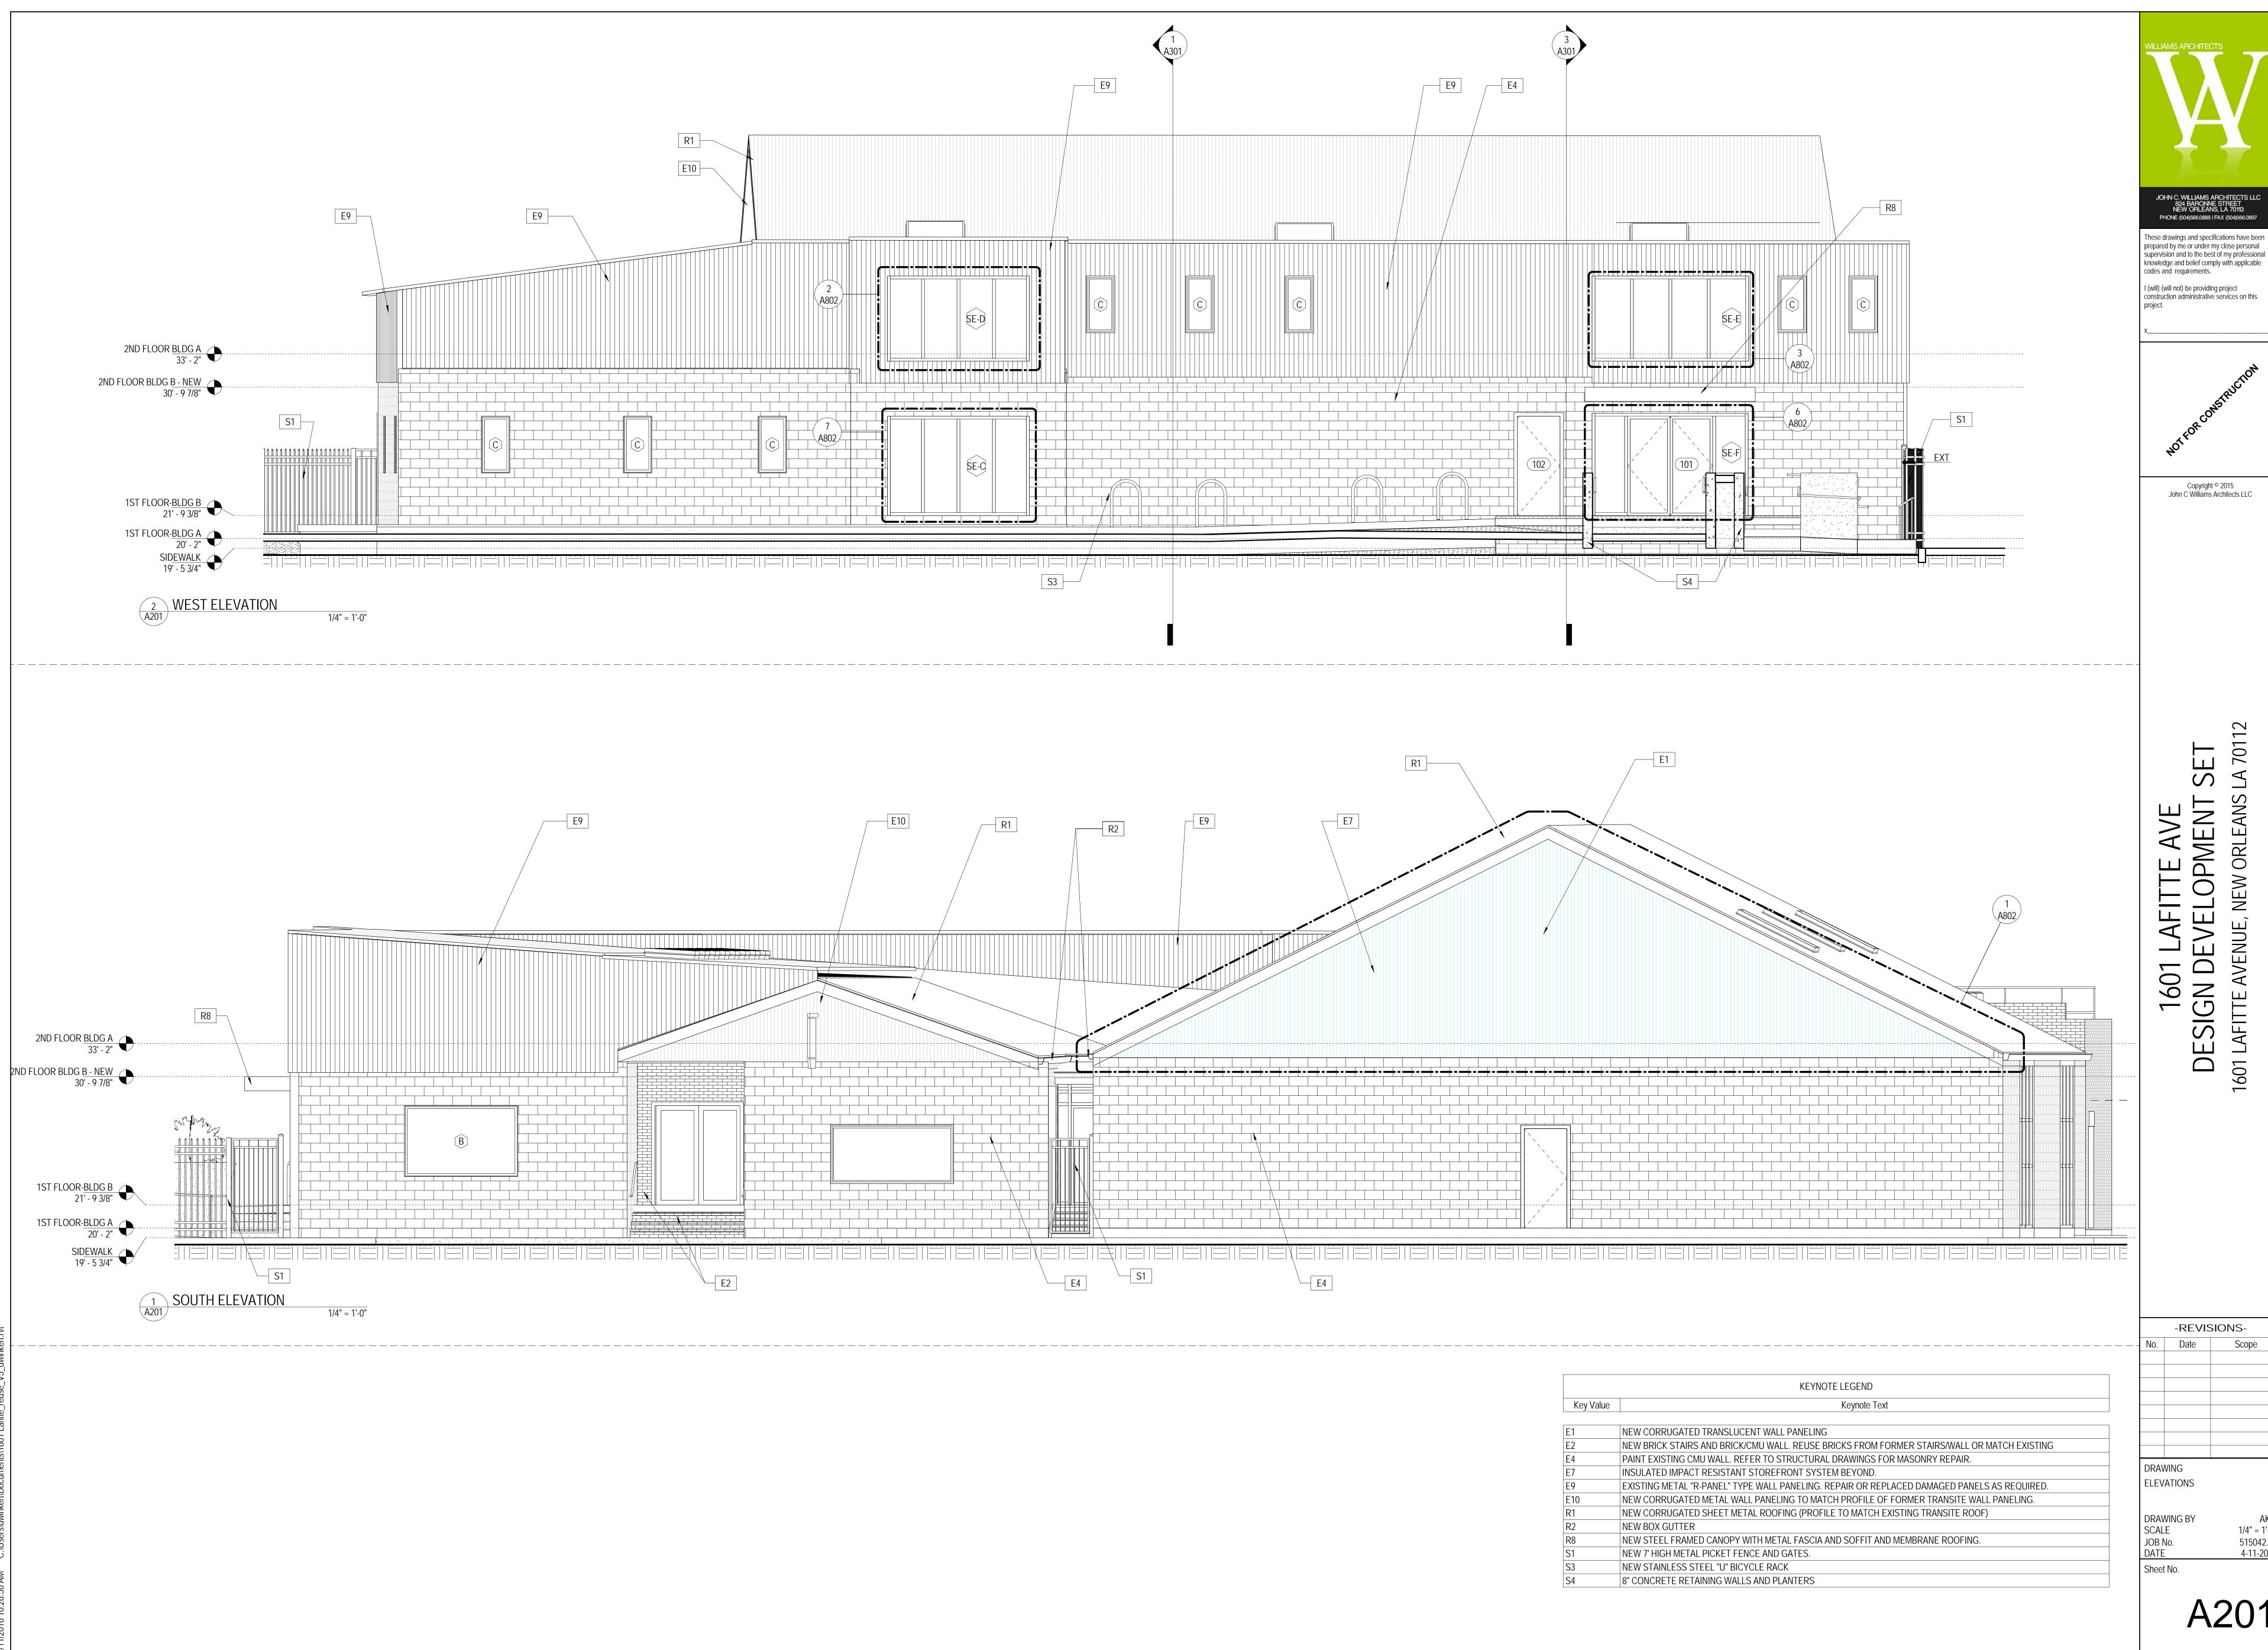
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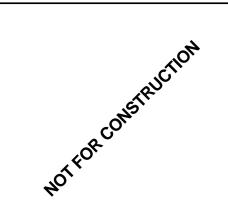
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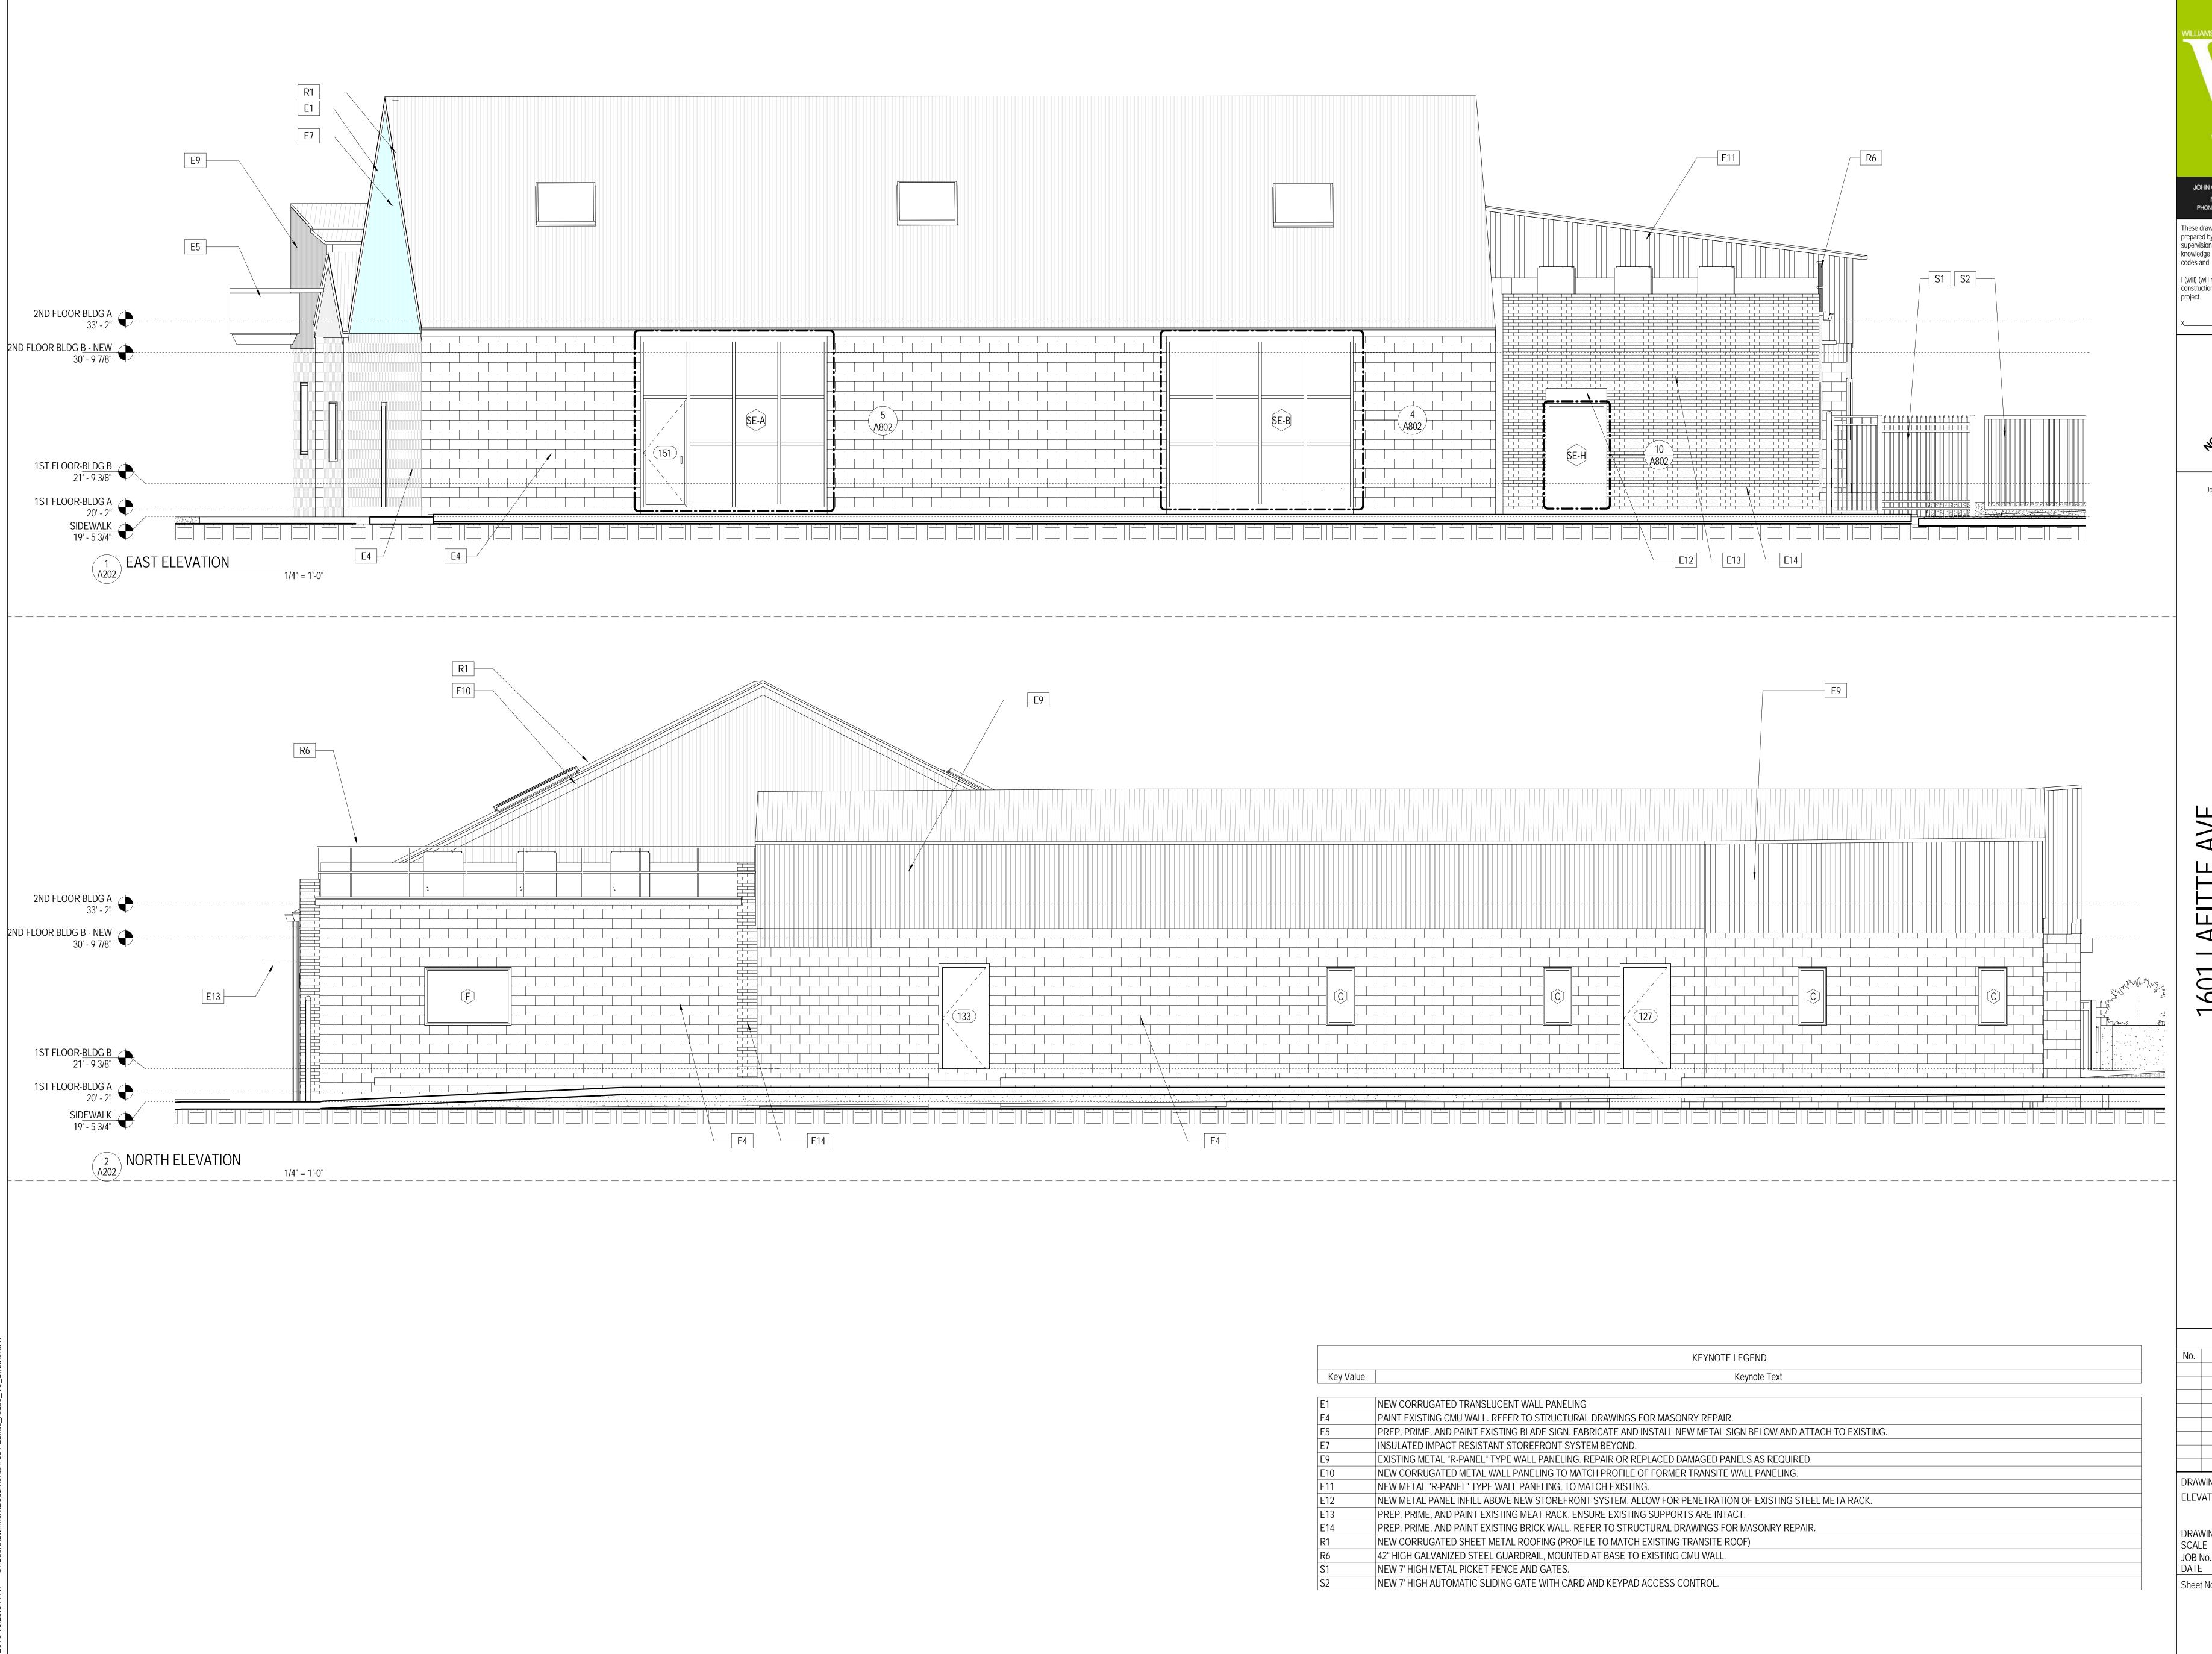
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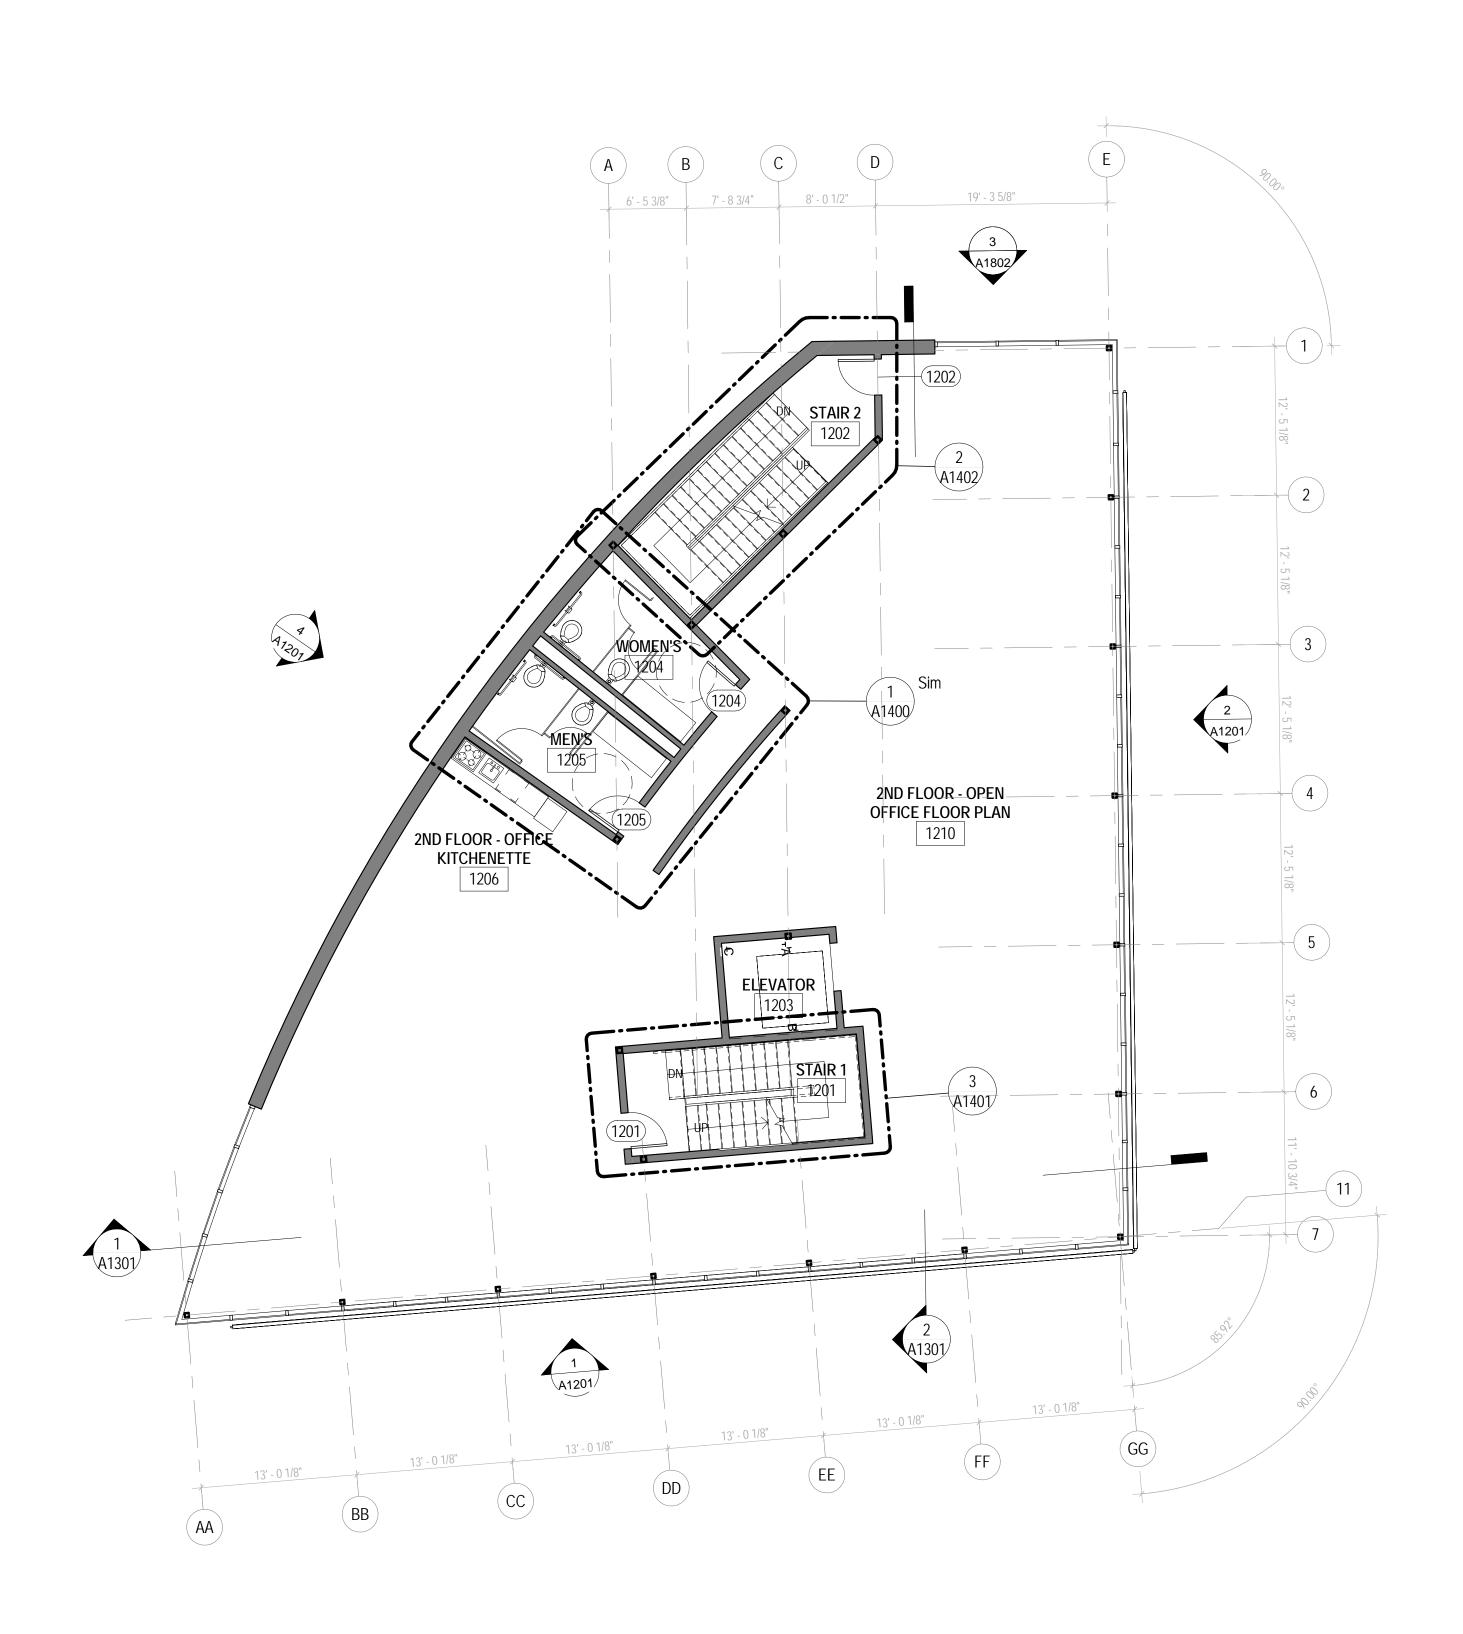
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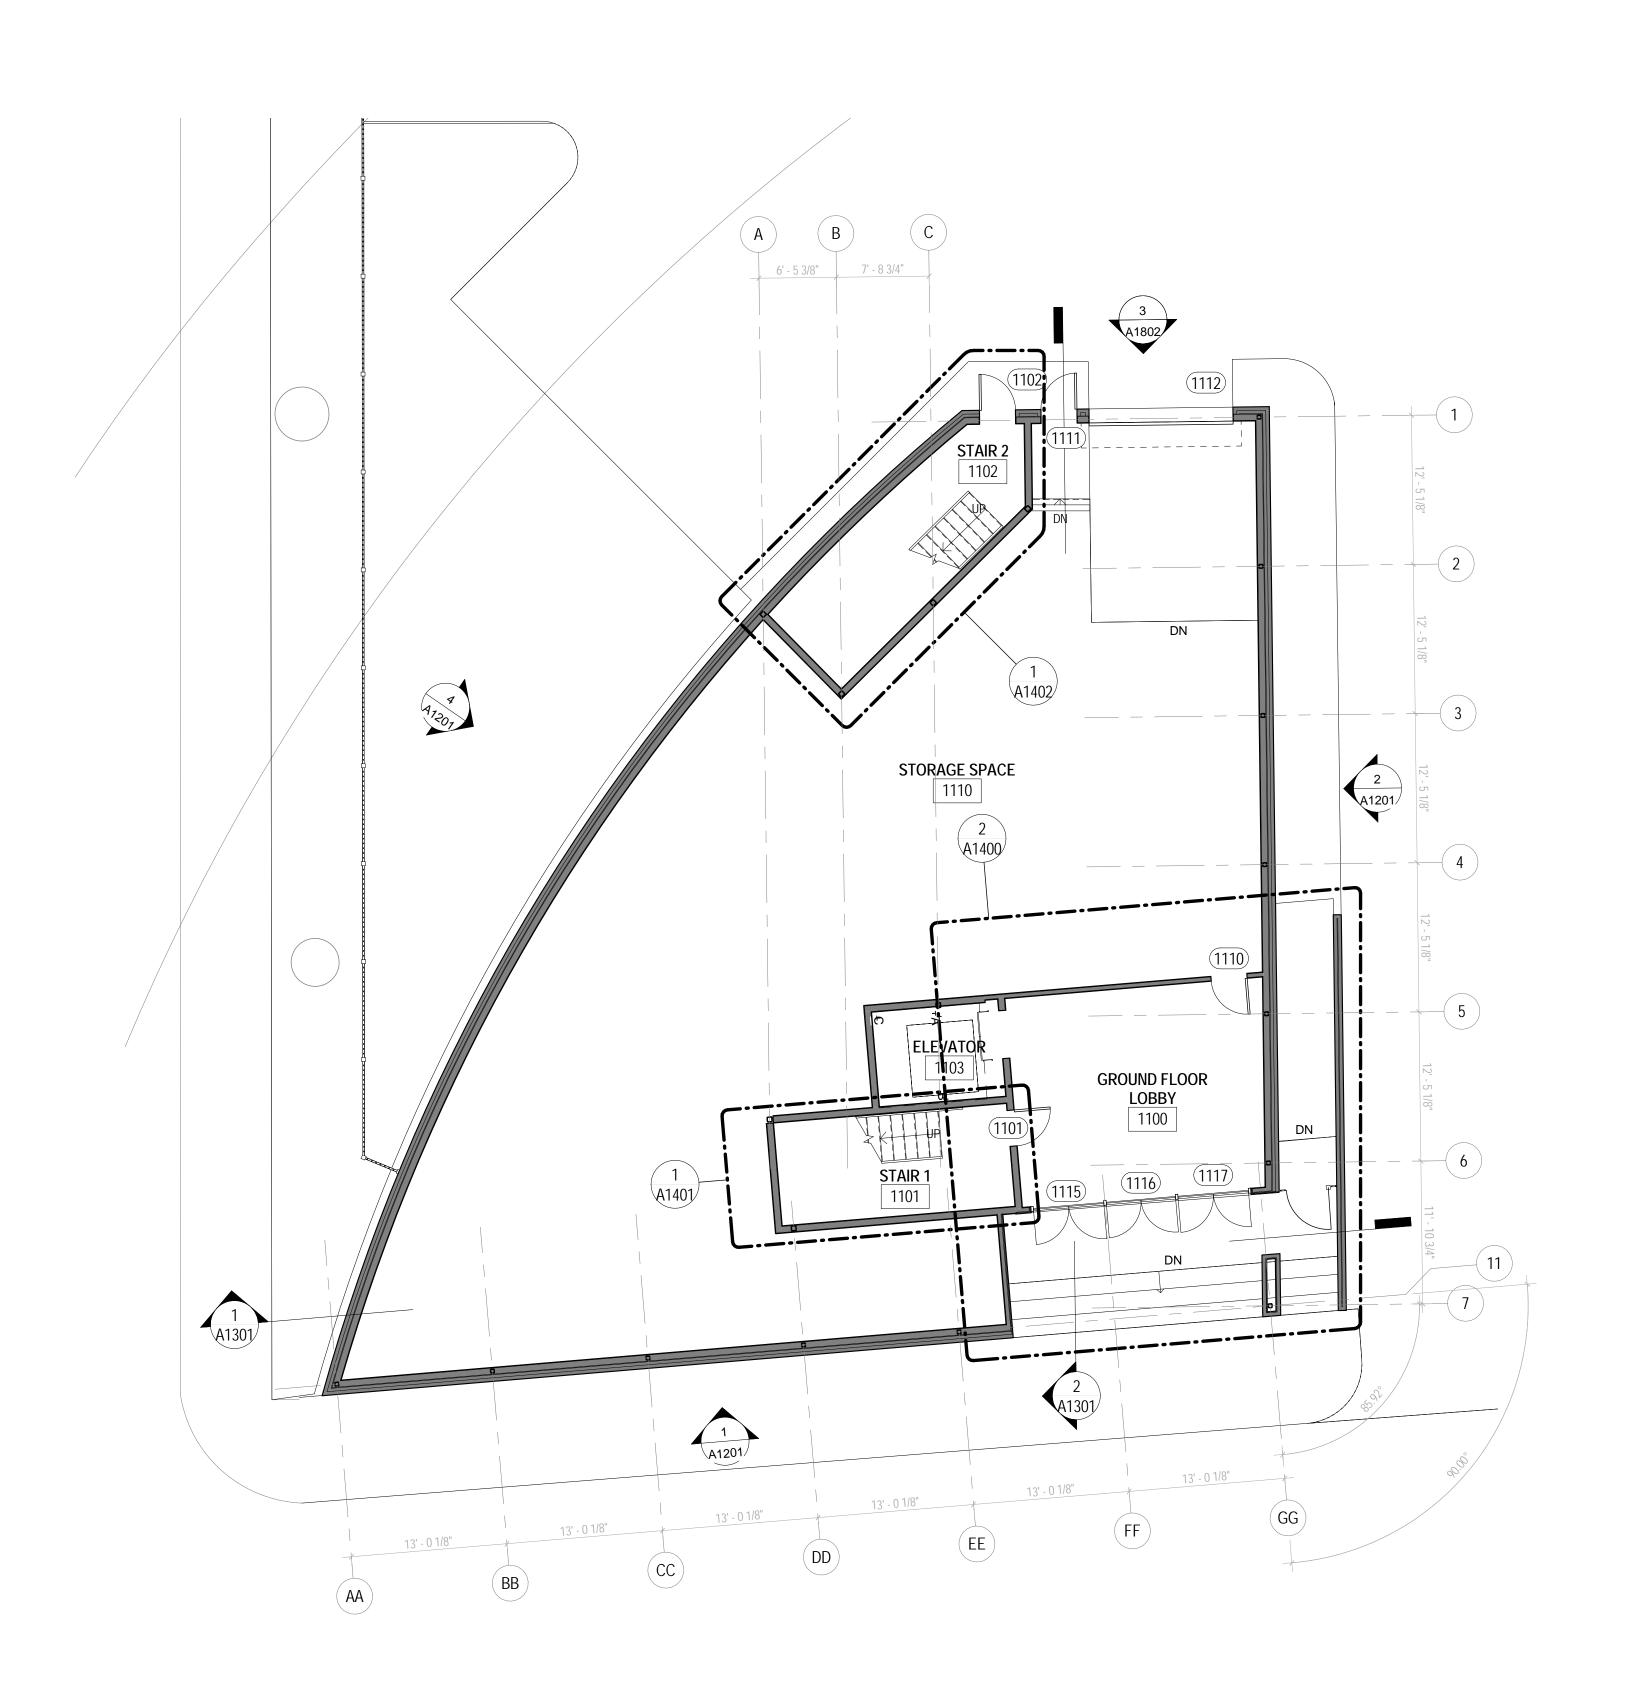
-REVISIONS-

DRAWING ELEVATIONS

DRAWING BY 1/4" = 1'-0" 515042.00


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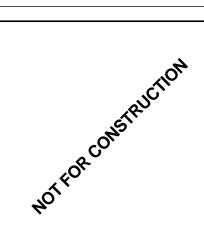
2 2ND FLOOR - NEW OFFICE BUILDING 1/8" = 1'-0"

1 NEW BUILDING FIRST FLOOR PLAN 1/8" = 1'-0"



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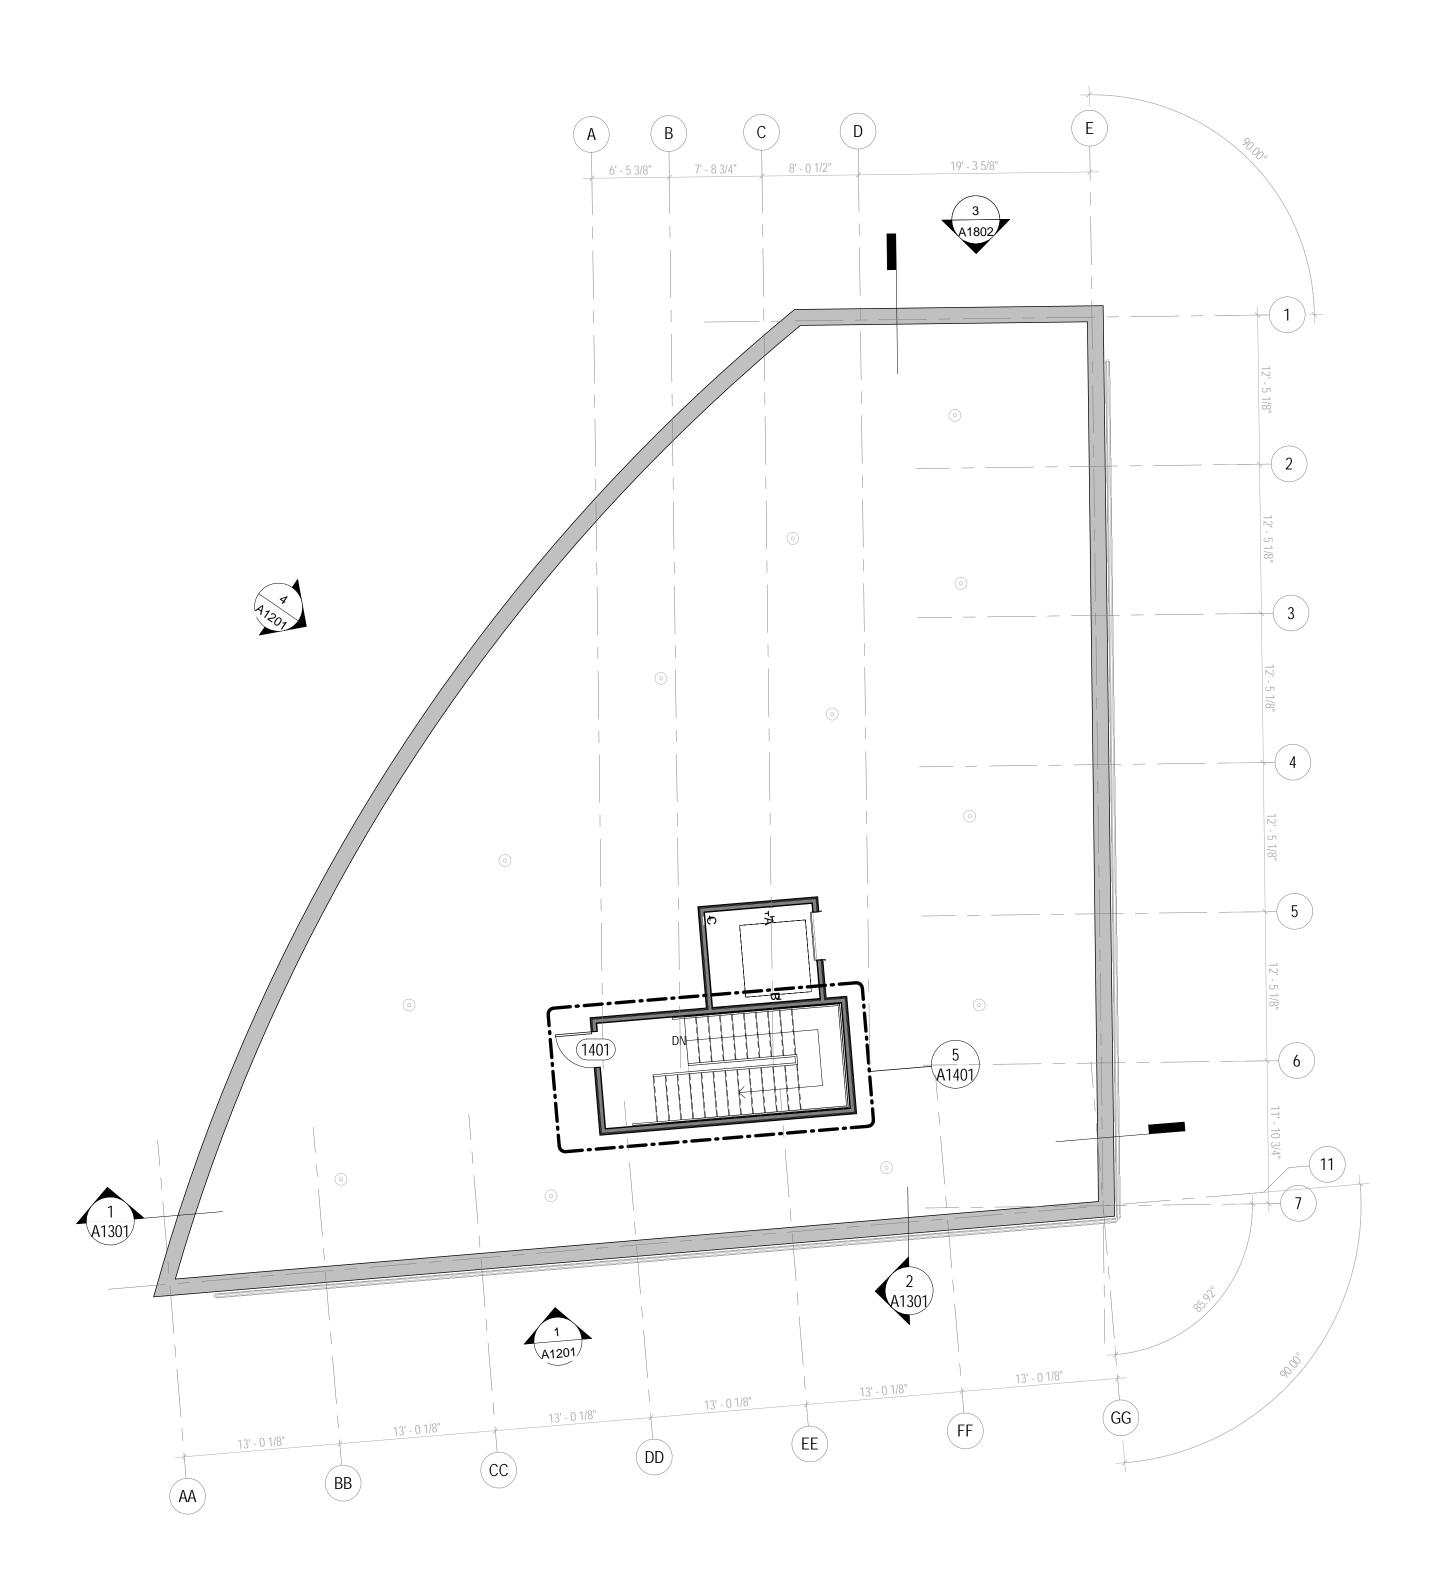


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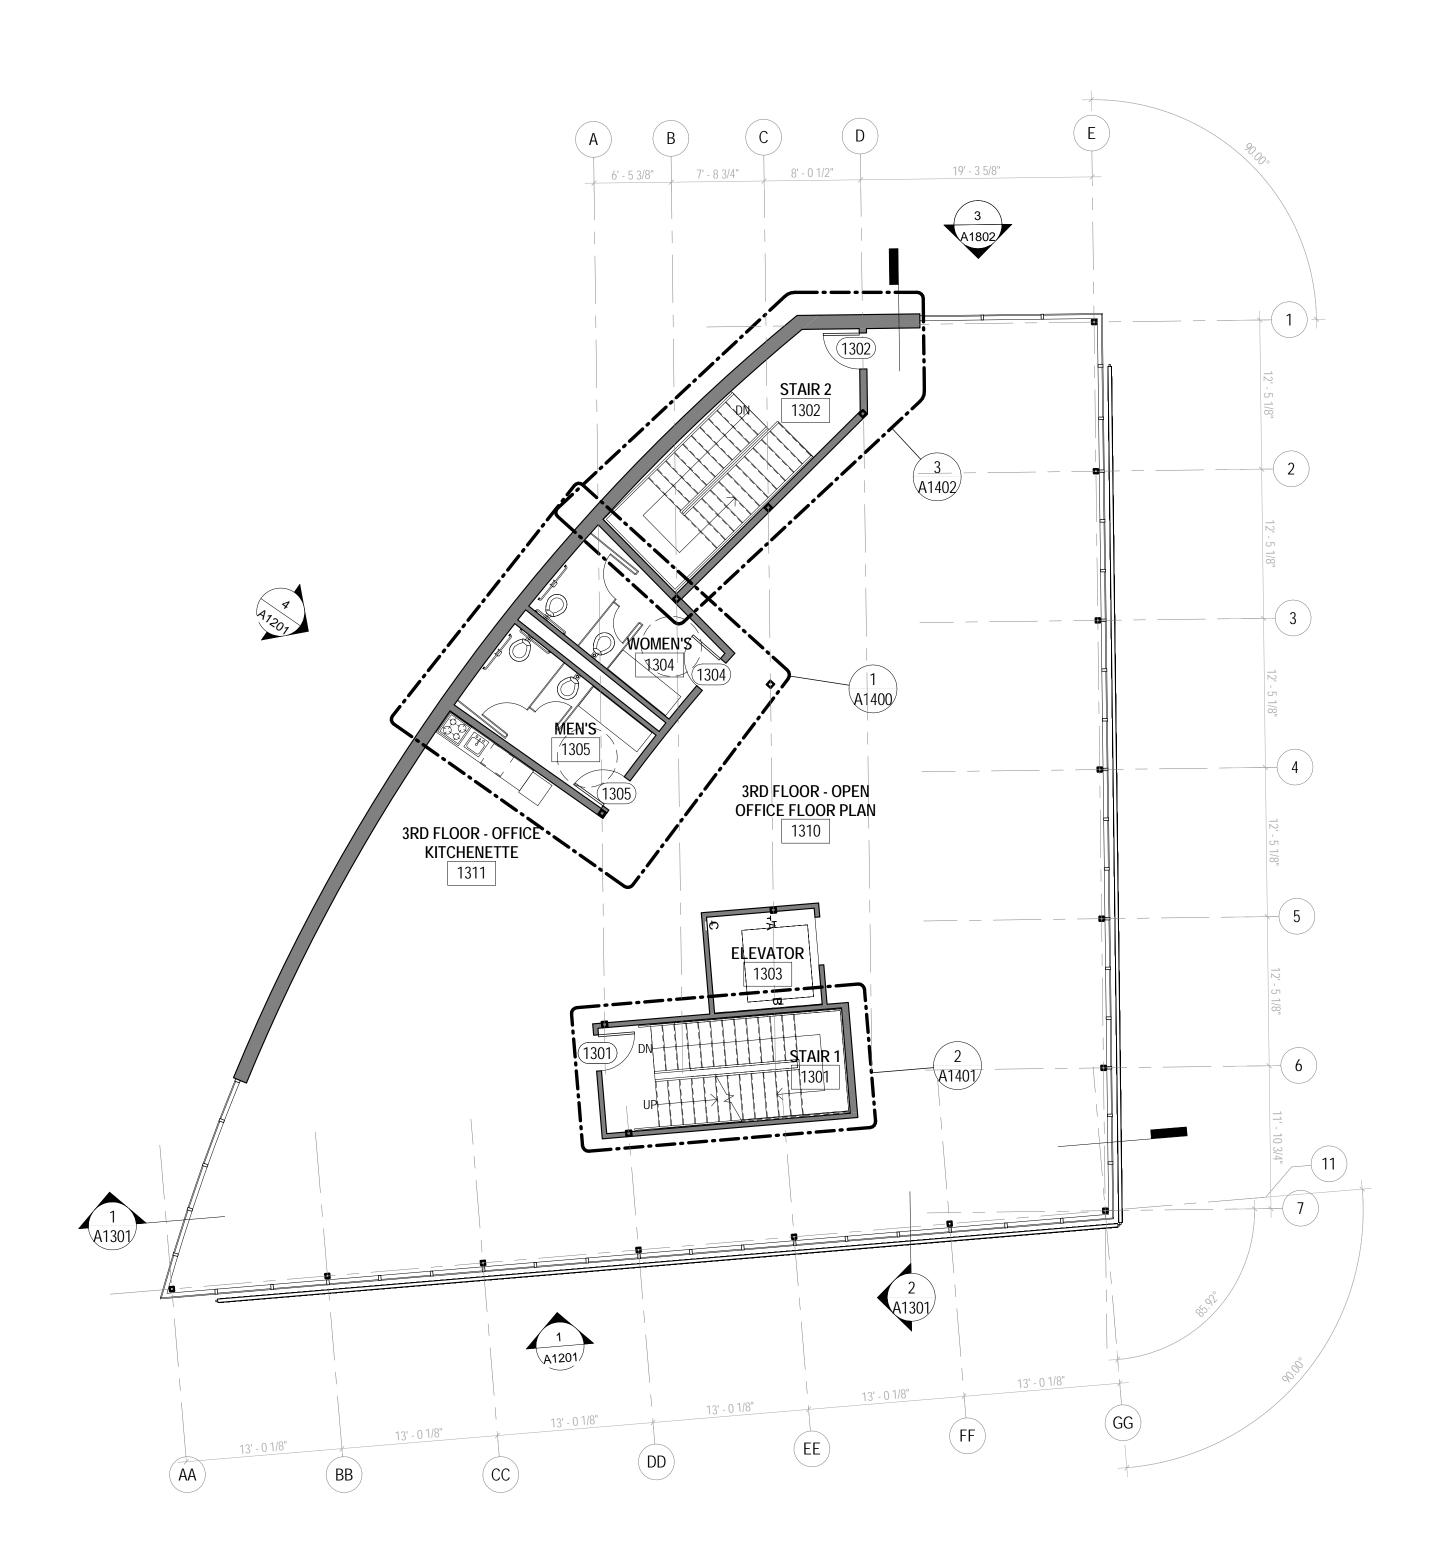
-REVISIONS-

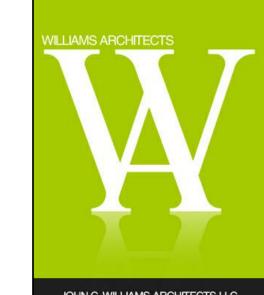NEW BUILDING FLOOR PLANS


Author 1/8" = 1'-0"








1 A1112 3RD FLOOR - NEW OFFICE BUILDING 1/8" = 1'-0"

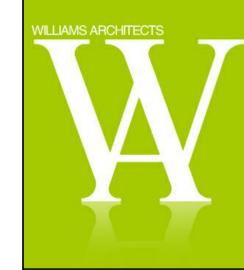

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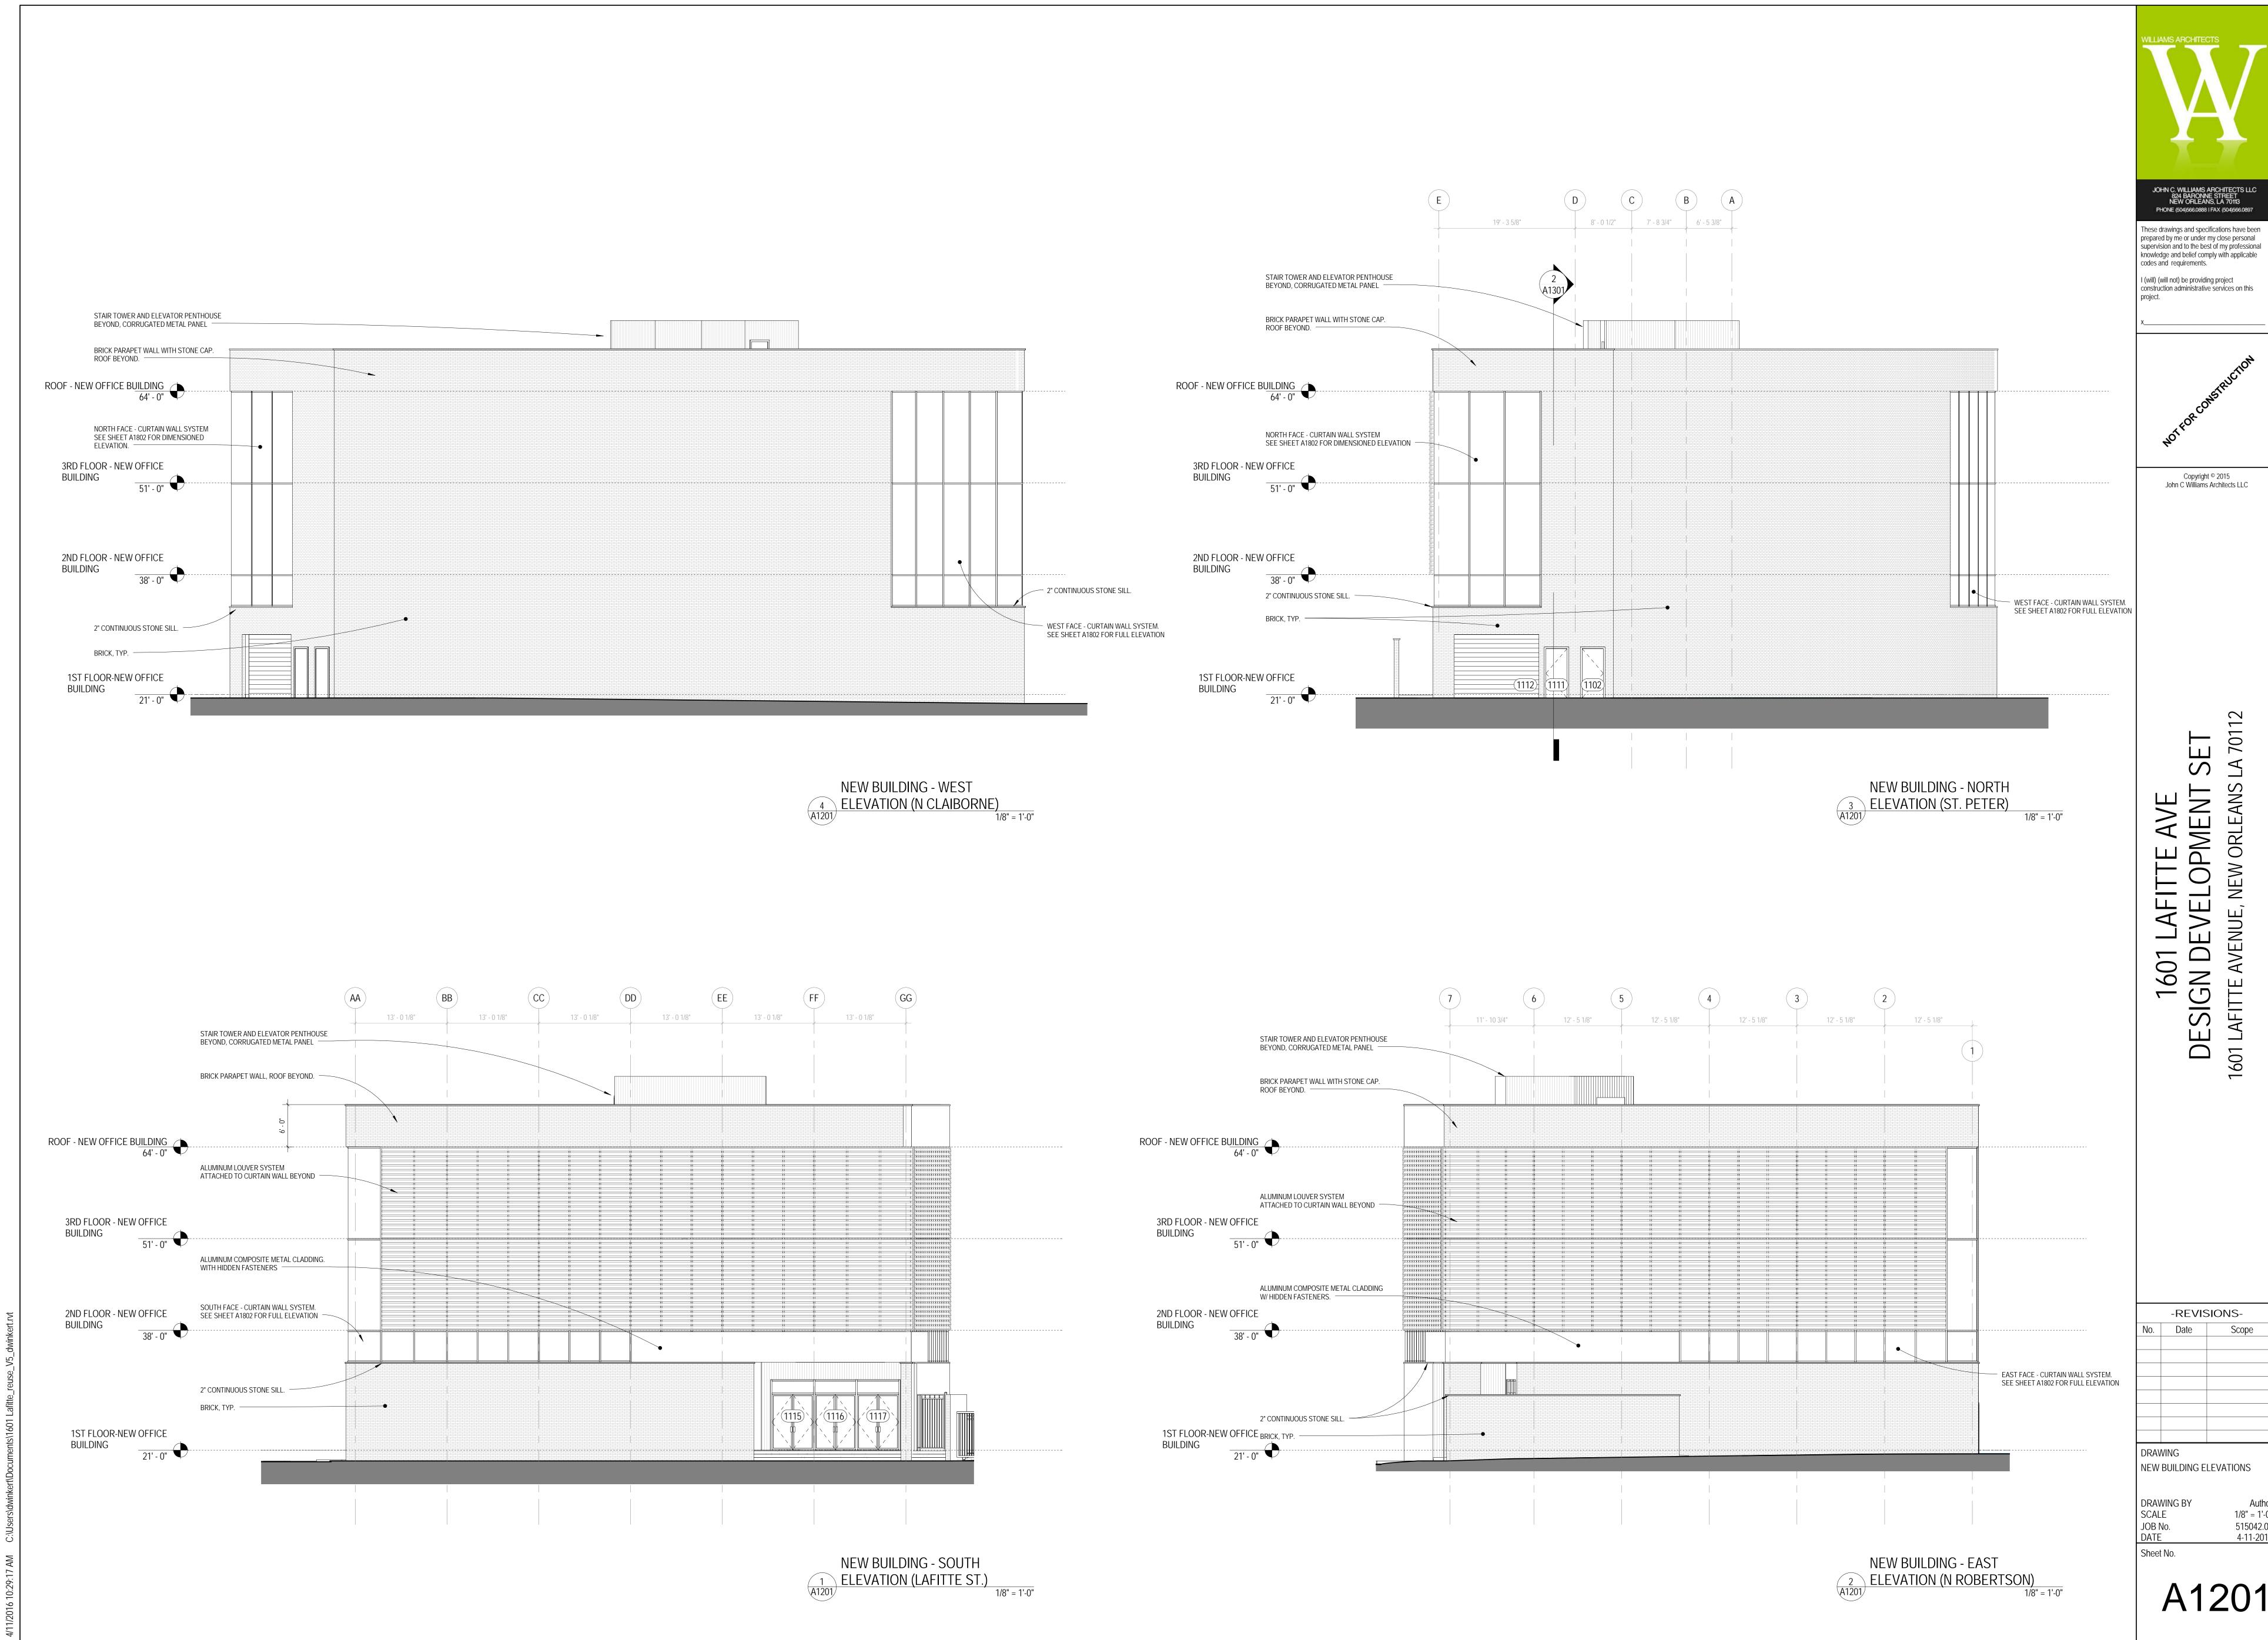
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NEW BUILDING FLOOR PLANS

A1112

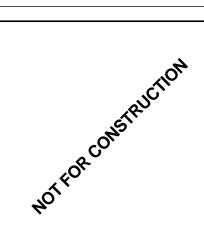Author 1/8" = 1'-0"



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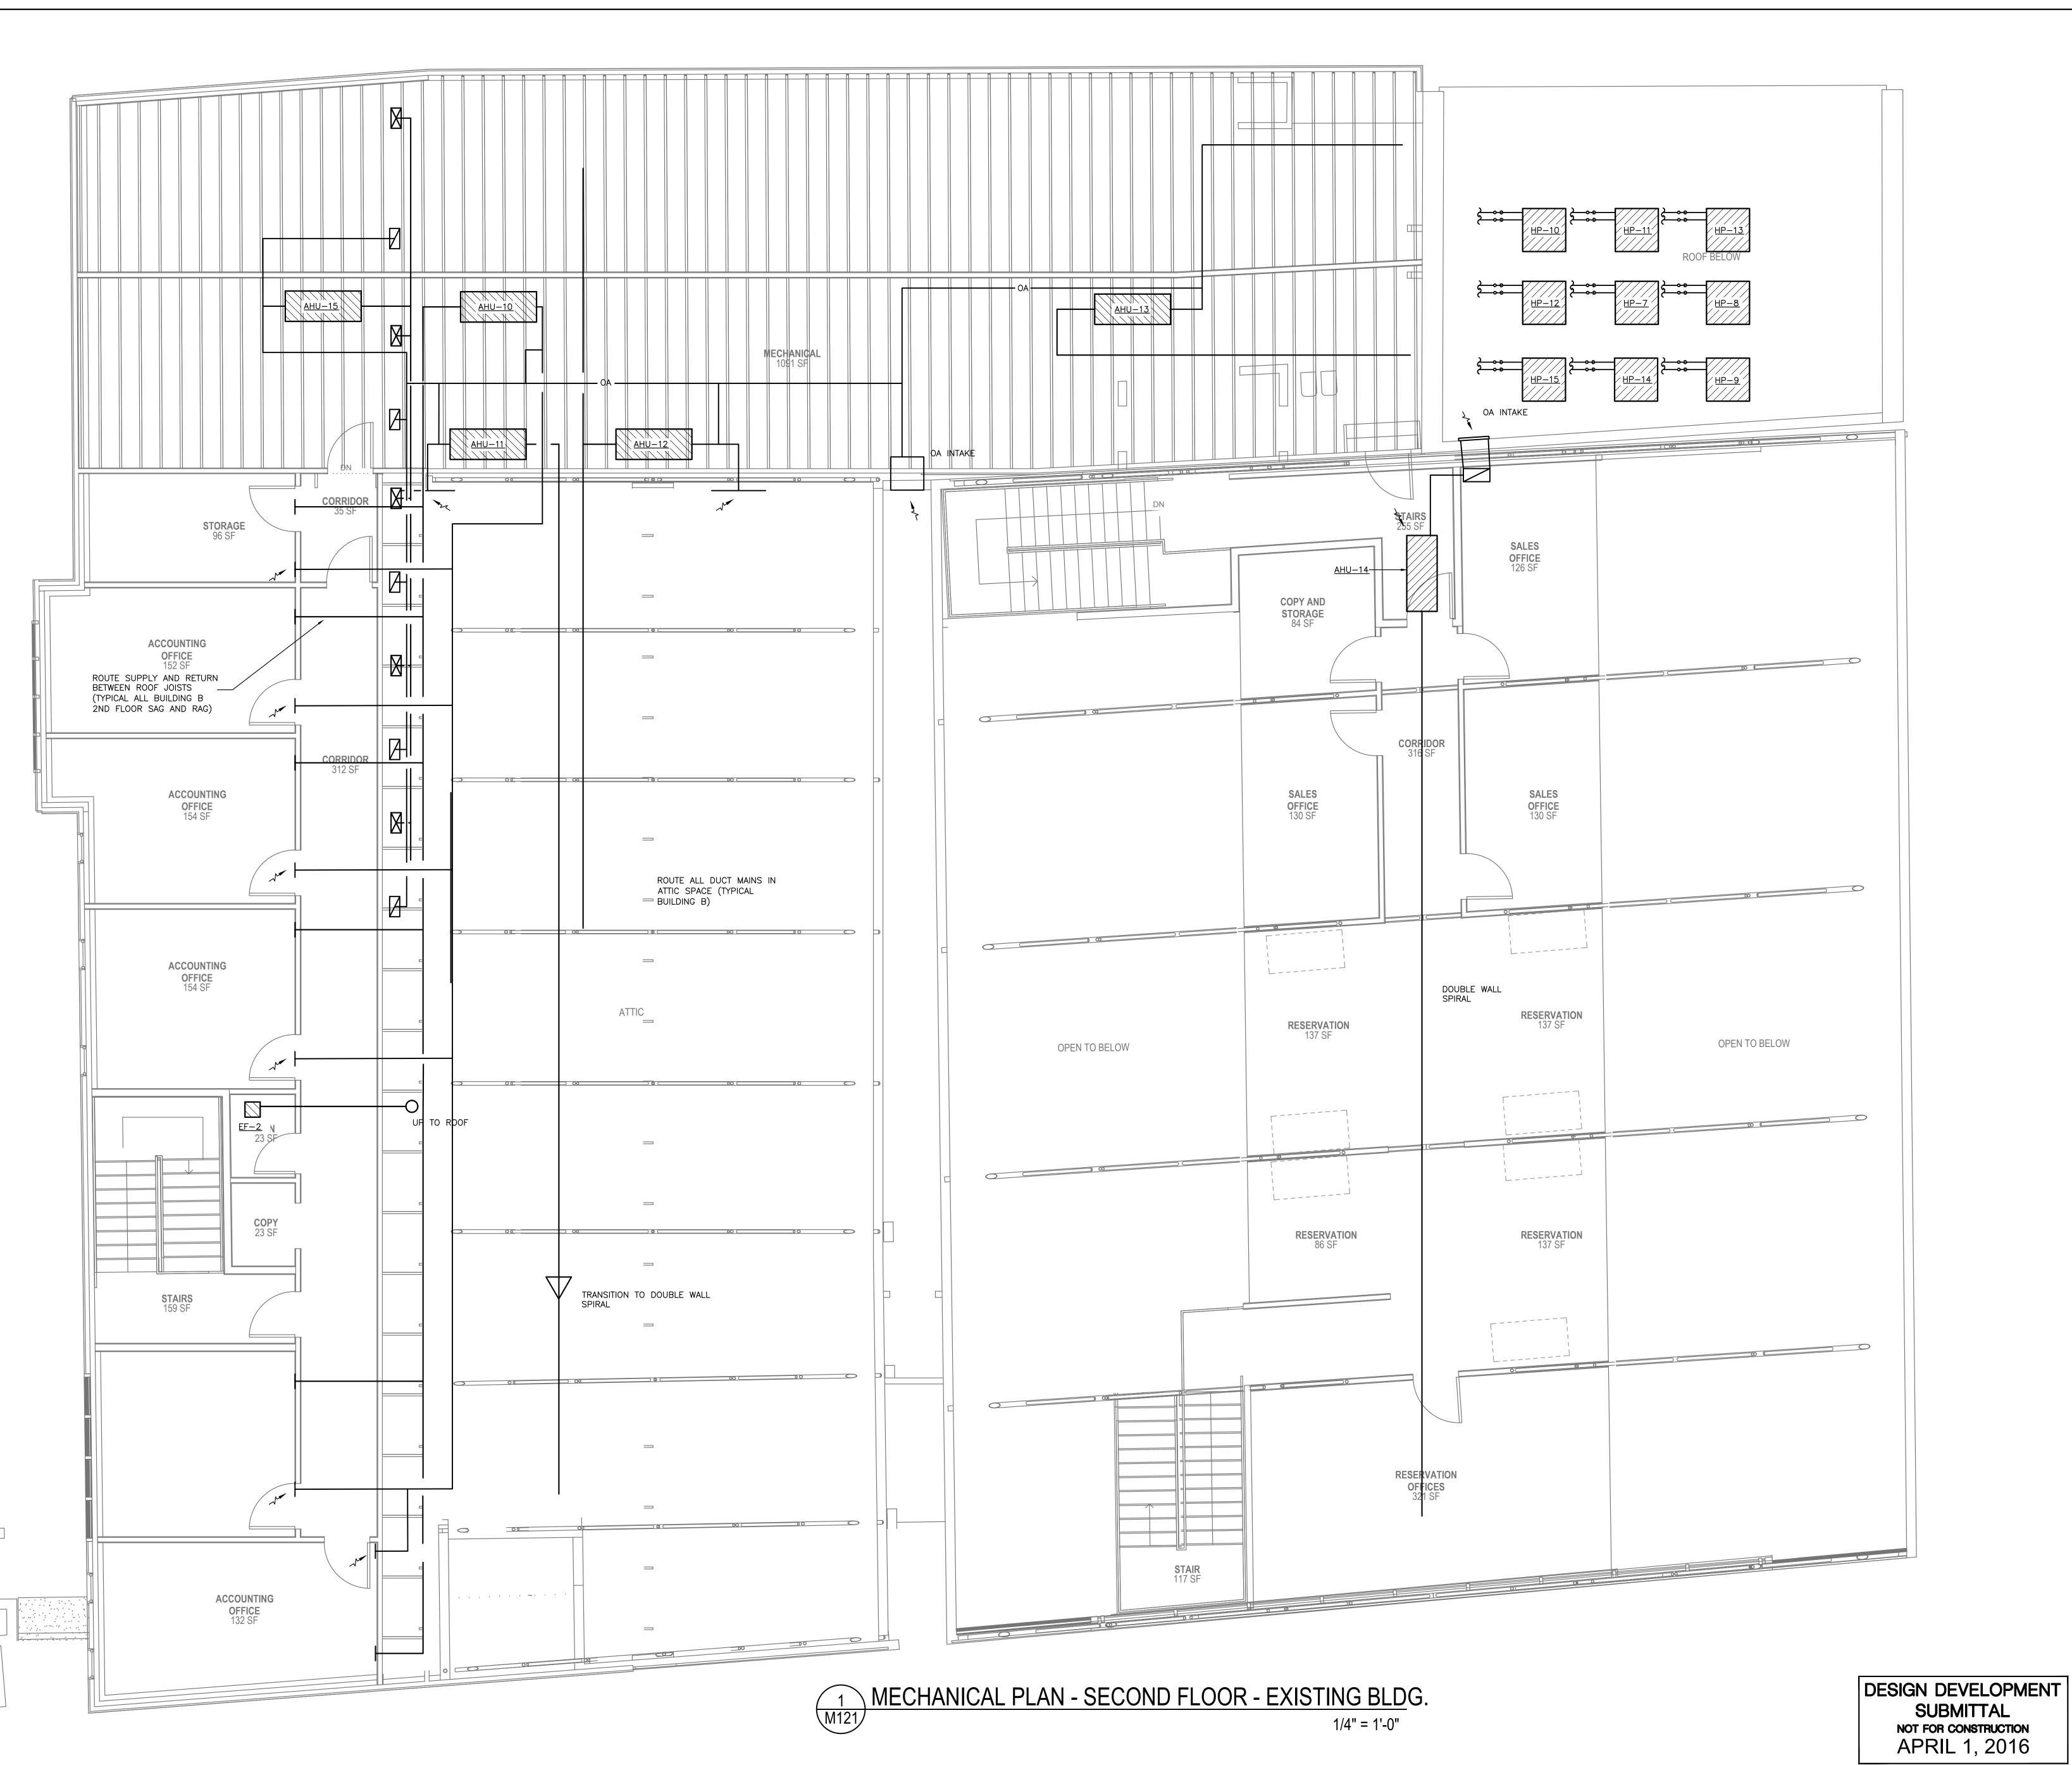
LAFITTE AVE EVELOPMENT **DESIGN D** 1601 LAFITTE


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1/8" = 1'-0" 515042.00

4-11-2016


A1201



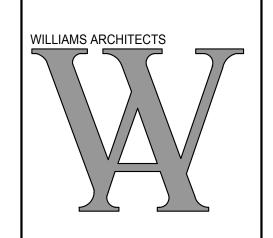

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DRAWING
MECHANICAL PLAN
SECOND FLOOR - EXISTING BLDG.


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INC. 3120 20th STREET METAIRIE, LOUISIANA 70002

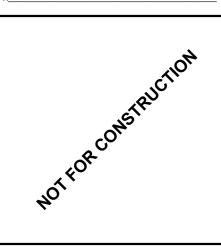M121



MECHANICAL PLAN - ROOF - NEW BLDG.


1/4" = 1'-0"

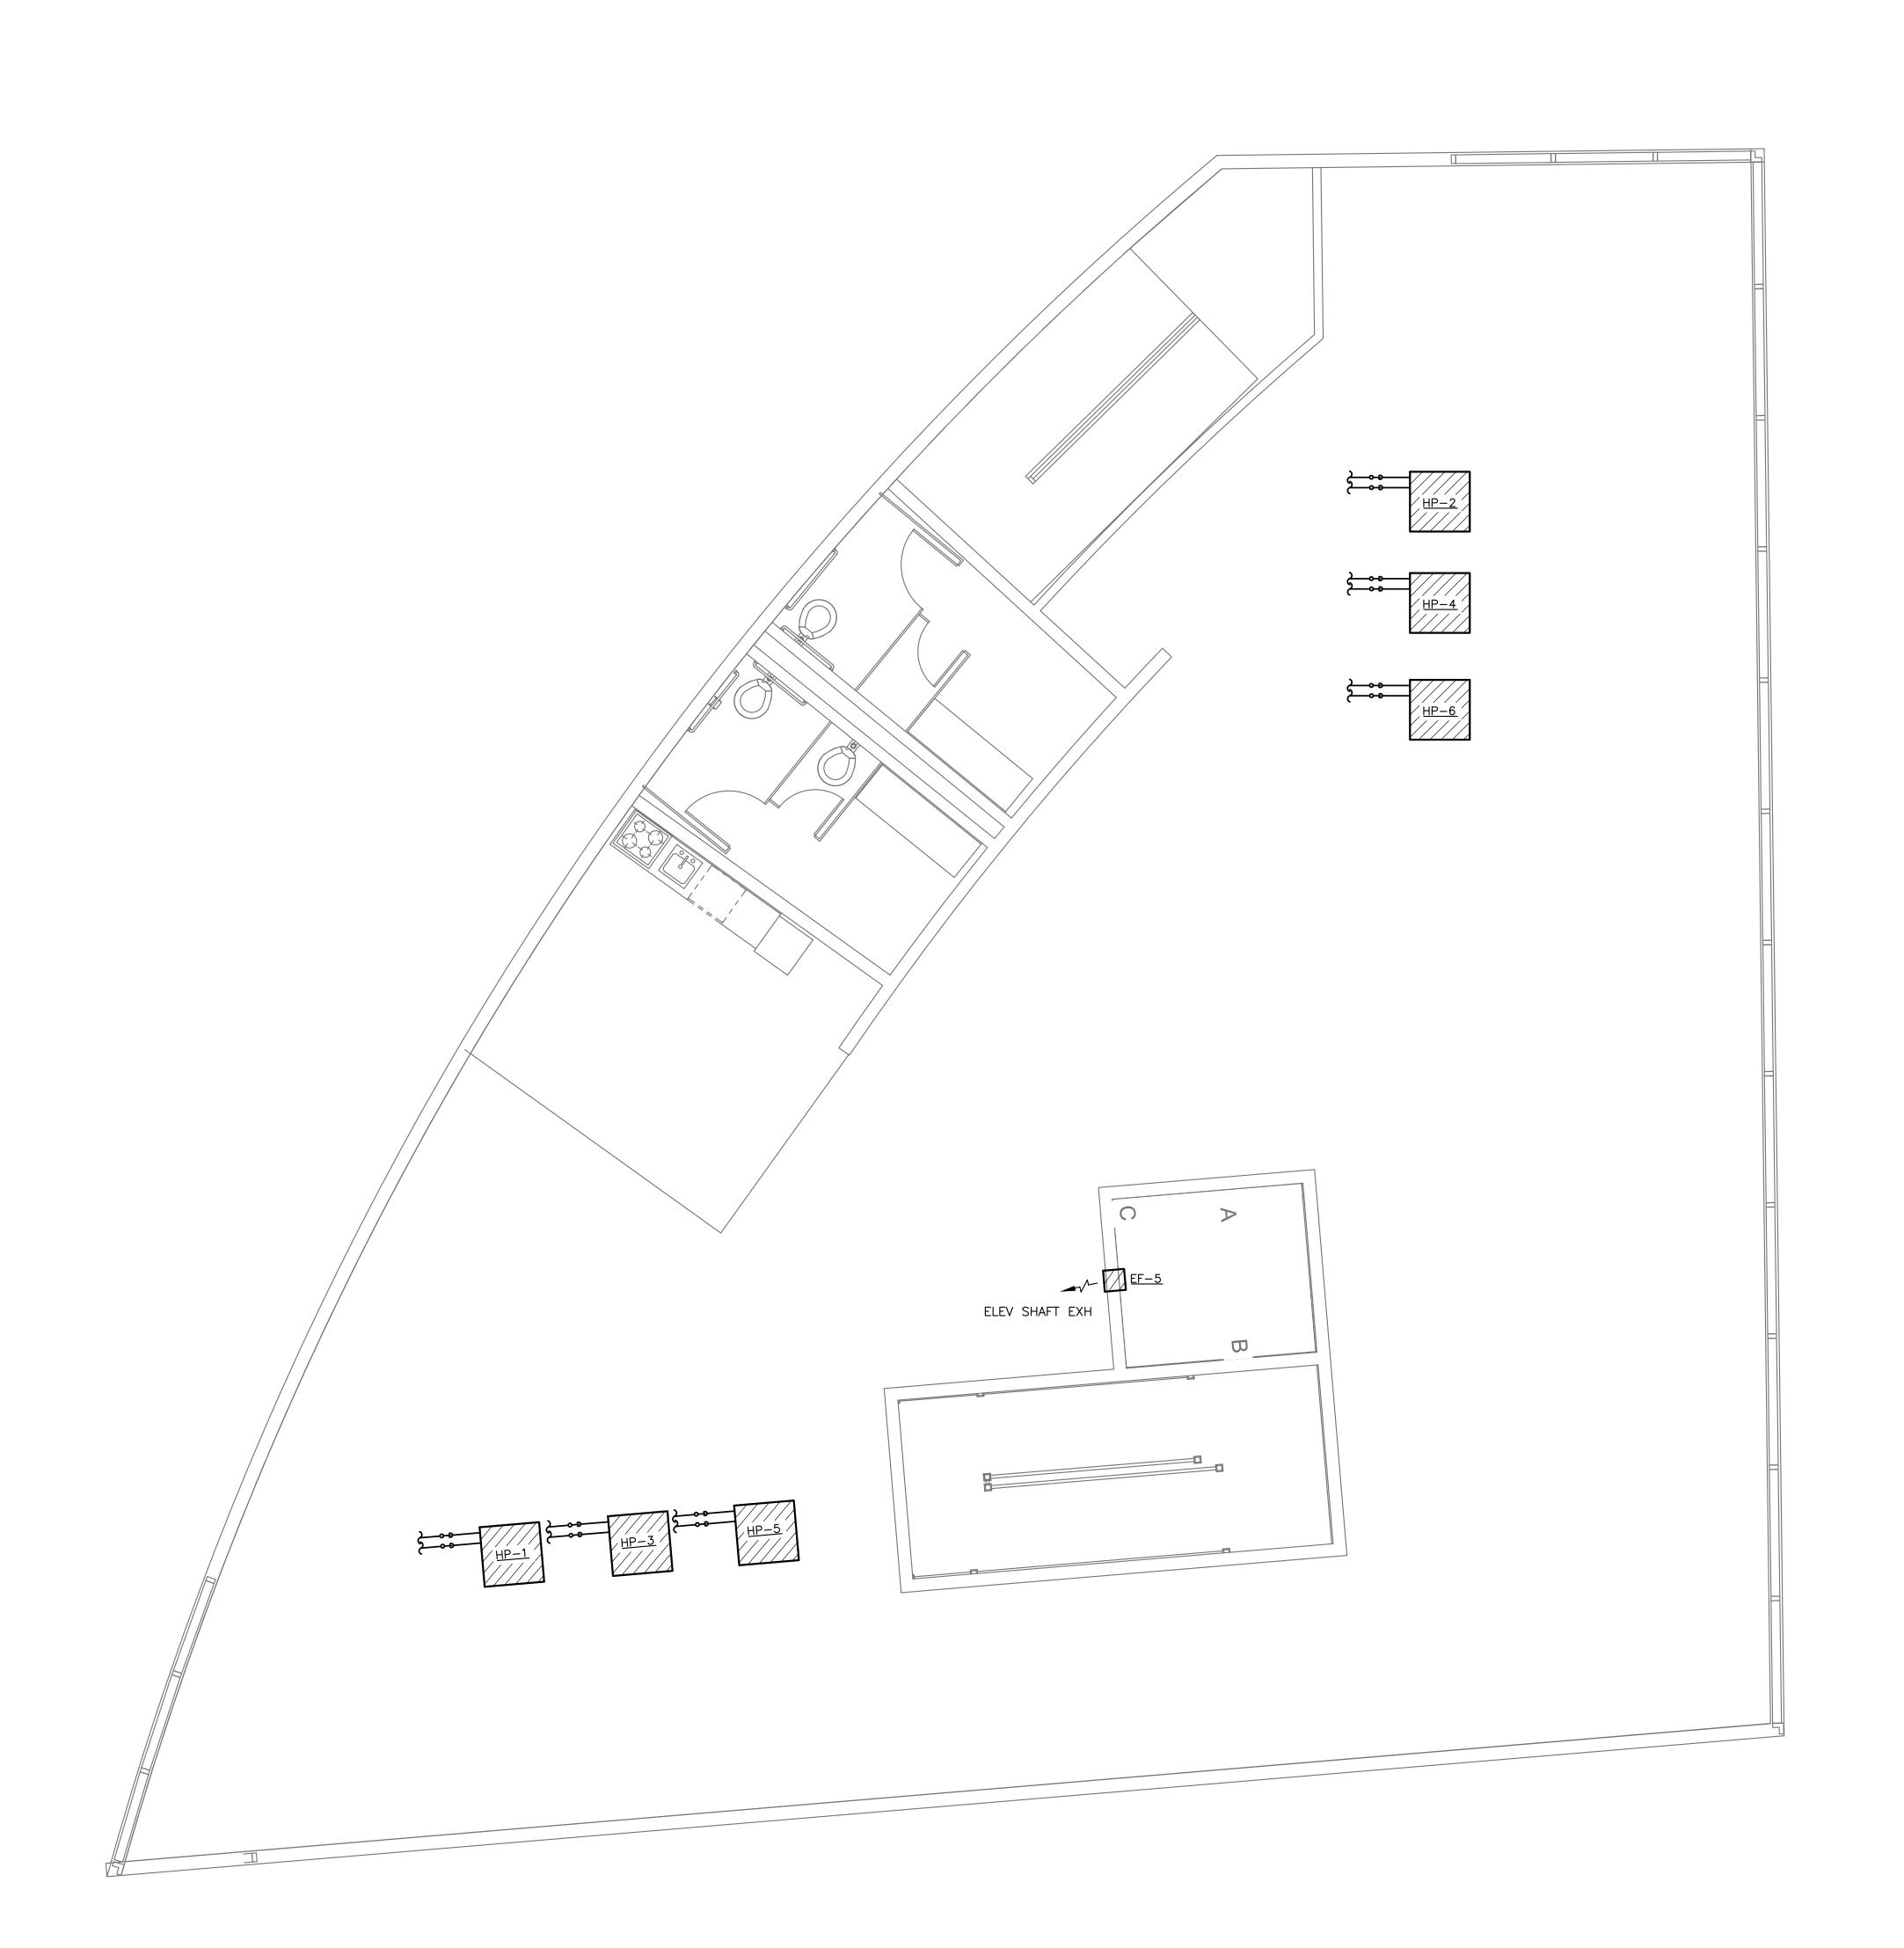DESIGN DEVELOPMENT SUBMITTAL NOT FOR CONSTRUCTION APRIL 1, 2016

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ALTERATIONS TO 1601 LAFITTE AVE

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DRAWING MECHANICAL PLAN ROOF - NEW BLDG.

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Sheet No.

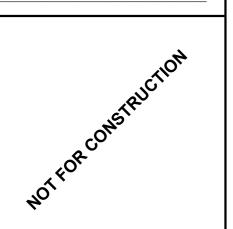M241

LANDSCAPE NOTES:

- I. ALL PLANTING MATERIALS USED SHALL BE OF GOOD QUALITY AND MEET AMERICAN ASSOCIATION OF NURSERYMEN (ANNS) STANDARDS FOR MINIMUM ACCEPTABLE FORM, QUALITY AND SIZE FOR SPECIES SELECTED, AND CAPABLE TO WITHSTAND THE SEASONAL TEMPERATURE VARIATIONS, AS WELL AS THE INDIVIDUAL SITE MICOR-CLIMATES.
- 2. ALL LANDSCAPE MATERIALS SHALL BE INSTALLED IN ACCORDANCE WITH THE CURRENT PLANTING PROCEDURES ESTABLISHED BY THE "LOUISIANA NURSERYMAN'S MANUAL FOR THE ENVIRONMENTAL HORTICULTURAL INDUSTRY," LATEST EDITION, AS PUBLISHED BY THE LOUISIANA NURSERY AND LANDSCAPE ASSOCIATION.
- 3. FOR ALL PROJECTS THAT INCLUDE LANDSCAPE AREAS NOT INCLUDED WITHIN STORMWATER BMP'S, AT LEAST 50% OF THE LANDSCAPED AREA SHALL BE DROUGHT-TOLERANT PLANTS. A MINIMUM OF 50% OF ALL REQUIRED LANDSCAPED AREAS SHALL BE DESIGNED, CONSTRUCTED AND MAINTAINED AS GREEN STORMWATER INFRASTRUCTURE FEATURES.
- 4. LANDSCAPE AREAS HAVING PLANTS WITH SIMILAR WATER NEEDS SHALL BE GROUPED TOGETHER AND IRRIGATED BY A DEDICATED IRRIGATION CONTROLLER STATION. ALL PLANTS LISTED IN THE LANDSCAPE PLAN SHALL BE CLASSIFIED AND GROUPED BY CATEGORY OF WATER USE CALCULATIONS. WATER USE CALCULATIONS SHALL BE GROUPED AS LOW, MEDIUM, AND HIGH.
- 5. THE IRRIGATION SYSTEM SHALL BE DESIGNED TO MINIMIZE THE USE OF WATER AND SHALL BE APPROVED AS PART OF THE LANDSCAPE PLAN. INSTALLED IRRIGATION SHALL COMPLY WITH THE FOLLOWING STANDARDS:
- 5.1. AUTOMATIC CONTROLLERS SHALL BE SET TO WATER BETWEEN 7P.M AND 10A.M. TO REDUCE EVAPORATION.
- 5.2. SYSTEM SHALL BE DESIGNED TO AVOID RUNOFF, LOW-HEAD DRAINAGE, OVERSPRAY, OR OTHER SIMILAR CONDITIONS WHERE WATER FLOWS OR DRIFTS ONTO ADJACENT PROPERTY, NON-IRRIGATIED AREAS, WALKS, ROADWAYS, OR STRUCTURES. 5.3. IRRIGATION EQUIPMENT SHALL COMPLY WITH THE FOLLOWING STANDARDS:
- 5.3.1. LOW-VOLUME IRRIGATION SYSTEMS WITH AUTOMATIC CONTROLLERS ARE REQUIRED. LOW-VOLUME IRRIGATION SYSTEMS INCLUDE LOW-VOLUME SPRINKLER HEADS, DRY EMITTERS, AND BUBBLER EMITTERS.
- 5.3.2. DRIP, TRICKLE OR OTHER LOW-VOLUME IRRIGATION SHALL BE PROVIDED ON AT LEAST 90% OF THE LANDSCAPE AREAS EXCEPT FOR THOSE AREAS DEVOTED TO TURF AND FLAT GROUNDCOVER PLANTS.
- 5.3.3. INTEGRAL, UNDER-THE-HEAD, OR IN-LINE ANTI-DRAIN VALVES SHALL BE INSTALLED AS NEEDED TO PREVENT LOW-HEAD DRAINAGE. 5.3.4. AUTOMATIC CONTROL SYSTEMS SHALL BE ABLE TO ACCOMMODATE ALL ASPECTS OF THE DESIGN. CONTROLLERS SHALL BE DIGITAL, HAVE MULTIPLE PROGRAMS,
- MULTIPLE CYCLES, AND SENSOR INPUT CAPABILITIES. 5.3.5. SOIL MOISTURE SENSORS AND RAIN OR MOISTURE-SENSING OVERRIDE DEVICES ARE MANDATORY.
- SPRINKLER HEADS SHALL BE SELECTED AND SPACED FOR PROPER AREA COVERAGE, APPLICATION RATE, OPERATING PRESSURE, AND ADJUSTMENT CAPABILITY. 5.3.7. DRIP IRRIGATION SYSTEMS ARE PERMITTED IF COMMERCIAL OR AGRICULTURAL
- GRADE MATERIALS ARE USED. 5.3.8. BACKFLOW PREVENTION DEVICES ARE REQUIRED.
- 6. THE OWNER OF RECORD IS RESPONSIBLE FOR THE MAINTENANCE, REPAIR, AND REPLACEMENT OF ALL LANDSCAPE MATERIALS OVER THE ENTIRE LIFE OF THE DEVELOPMENT. 7. LANDSCAPE MATERIALS SHALL BE MAINTAINED IN GOOD CONDITION, PRESENT A HEALTHY, NEAT AND ORDERLY APPEARANCE, AND KEPT FREE OF WEEDS, REFUSE, AND DEBRIS. ANY DEAD, UNHEALTHY, OR MISSING PLANTS SHALL BE REPLACED WITHIN 6 MONTHS OF NOTIFICATION BY THE CITY. IRRIGATION SYSTEMS SHALL BE MAINTAINED IN GOOD OPERATING
- 8. NEW DEVELOPMENT SHOULD PROMOTE SAFE, CONVENIENT AND ATTRACTIVE PEDESTRIAN AND BICYCLE ACCESS TO THE LAFITTE GREENWAY.
- 9. WHEN ADJACENT TO SIDEWALKS, TREES SHALL HAVE A MINIMUM HEIGHT OF 12' AT PLANTING, WITH A MINIMUM CANOPY CLEARANCE OF 6.5' TO ALLOW PEDESTRIAN PASSAGE.
- 10. ALL DECIDUOUS SHADE TREES AT THE TIME OF INSTALLATION SHALL HAVE A MINIMUM CALIPER OF 2.5" FOR SINGLE TRUNK TREES, AND 1.25" FOR MULTI-TRUNK TREES, AND A CLEAR TRUNK HEIGHT OF AT LEAST 6'.
- II. EVERGREEN TREES SHALL HAVE A MINIMUM HEIGHT OF 8' AT PLANTING. 12. SINGLE-STEM ORNAMENTAL TREES SHALL HAVE A MINIMUM CALIPER OF 3". MULTI-STEM
- ORNAMENTAL TREES SHALL HAVE A MINIMUM HEIGHT OF 8' AT PLANTING AND A MINIMUM OF 3 TRUNKS WITH A MINIMUM 1.5" CALIPER EACH, WITH 5 TRUNKS MAXIMUM. 13. LARGE DECIDUOUS AND EVERGREEN SHRUBS SHALL HAVE A MINIMUM HEIGHT OF 3' AT
- INSTALLATION, AND SMALL SHRUBS SHALL HAVE A MINIMUM HEIGHT OF 18" AT INSTALL. 14. PERENNIALS AND GROUNDCOVER SHALL BE A MINIMUM OF 4" CONTAINER STOCK. 15. MULCH SHALL BE A MINIMUM OF 2" THICK DRESSING AND SHALL BE APPLIED ON ALL
- EXPOSED SOIL SURFACES, EXCEPT TURF, CREEPING OR ROOTING GROUNDCOVERS, OR DIRECT SEEDING APPLICATIONS. MULCH SHALL BE KEPT FROM DIRECT CONTACT WITH TREE TRUNKS AND ORGANIC MATERIALS. ALL MULCH SHALL DERIVE FROM A LIVING NATURAL SOURCE.

CONT SIZE

CONT SIZE

3 gal 3 - 5 HT

SPACING

24" o.c.

16. LANDSCAPE INSTALLATION AND MAINTENANCE SHALL BE PERFORMED IN A SUSTAINABLE MANNER, SUBJECT TO THE LANDSCAPE PRINCIPLES PUBLISHED BY THE LSU AG-CENTER, LOUISIANA YARDS AND NEIGHBORHOODS (LYN) PROGRAM, A GUIDE TO LOUISIANA-FRIENDLY LANDSCAPING, LATEST ADDITION.

| 30 gal | 6` - 8` HT Japanese Maple / Acer palmatum `Bloodgood` Summer Red Red Maple / Acer rubrum `Summer Red` | 45 gal | 12` HT., MIN. | 2.5" Cal. River Birch / Betula nigra 45 gal | 12` HT., MIN. | 2.5" Cal. Eastern Redbud / Cercis canadensis 45 gal | 10` - 12` HT. | 2.5" Cal. 1.5" Cal Sweet Bay / Magnolia virginiana 3-5 TRUNKS MINIMUM & MAXIMUM Yew Pine / Podocarpus macrophyllus 30 gal | 6` Ht. CONT SIZE SPACING COMMON NAME / BOTANICAL NAME |3 gal | 15"HT X 15"W 48" o.c. Encore Azalea / Azalea Encore Autumn Lily 3 gal | 15"HT X 15"W Camellia / Camellia sasanqua `Shishi-Gashira 48" o.c. Scarlet Rosemallow / Hibiscus coccineus 60" o.c. 3 gal 18"HT X 15"W Oakleaf Hydrangea / Hydrangea quercifolia 60" o.c. 3 gal 12"HT. X 15"W. 42" o.c. Dwarf Yaupon / Ilex vomitoria `Stokes Dwarf` 3 gal 15"HT X 15"W Zebra Grass / Miscanthus sinensis `Zebrinus` 36" o.c. Dwarf Palmetto / Sabal minor |7 gal | 3` - 4` HT. 60" o.c. ANNUALS/PERENNIALS | COMMON NAME / BOTANICAL NAME CONT SIZE SPACING |1 gal | |12"HT. X 15"W. Blue Swamp Iris / Iris Iouisiana `Blue` 1 gal 15"HT X 15"W 24" o.c. Yellow Iris / Iris Iouisiana 'Yellow' **GRASSES** COMMON NAME / BOTANICAL NAME CONT SIZE SPACING 1 gal 12"HT X 12"W 18" o.c. Big Blue Lilyturf / Liriope muscari `Big Blue`


COMMON NAME / BOTANICAL NAME

Creeping Fig / Ficus pumila

VINE/ESPALIER

These drawings and specifications have been prepared by me or under my close personal supervision and to the best of my professional knowledge and belief comply with applicable codes and requirements.

I (will) (will not) be providing project construction administrative services on this

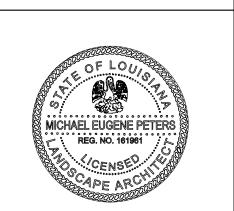

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-REVISIONS-No. Date DRAWING: LANDSCAPE PLAN

DRAWING BY: GENE PETERS 3/32" = 1'-0" JOB No. 515042.00 4-07-2016 Sheet No.

NORTH

SCALE: 3/32" = 1'-0"

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LA 70112

1601 LAFITTE AVE
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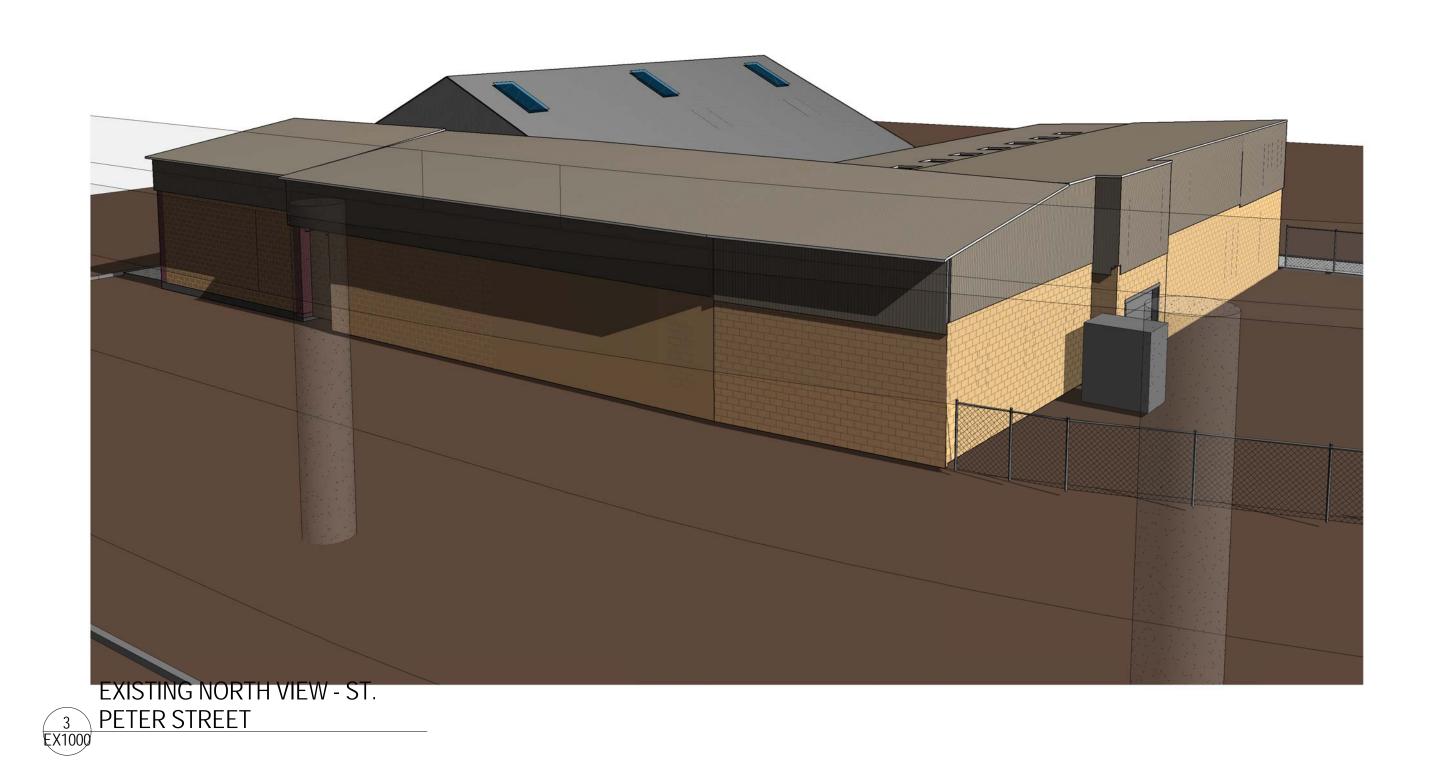
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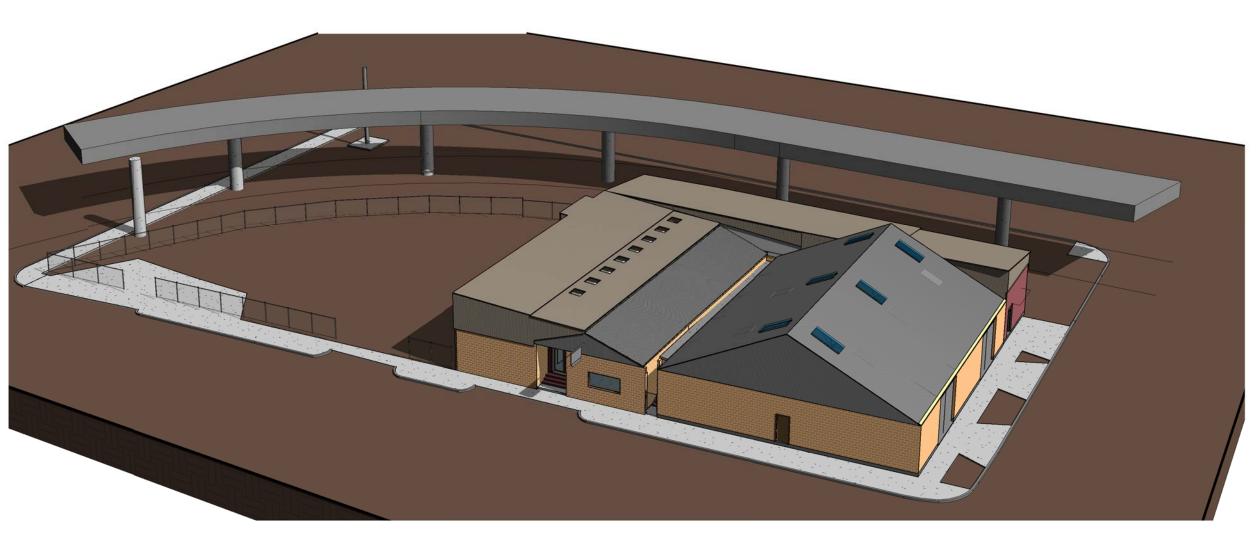
EXISTING VIEWS

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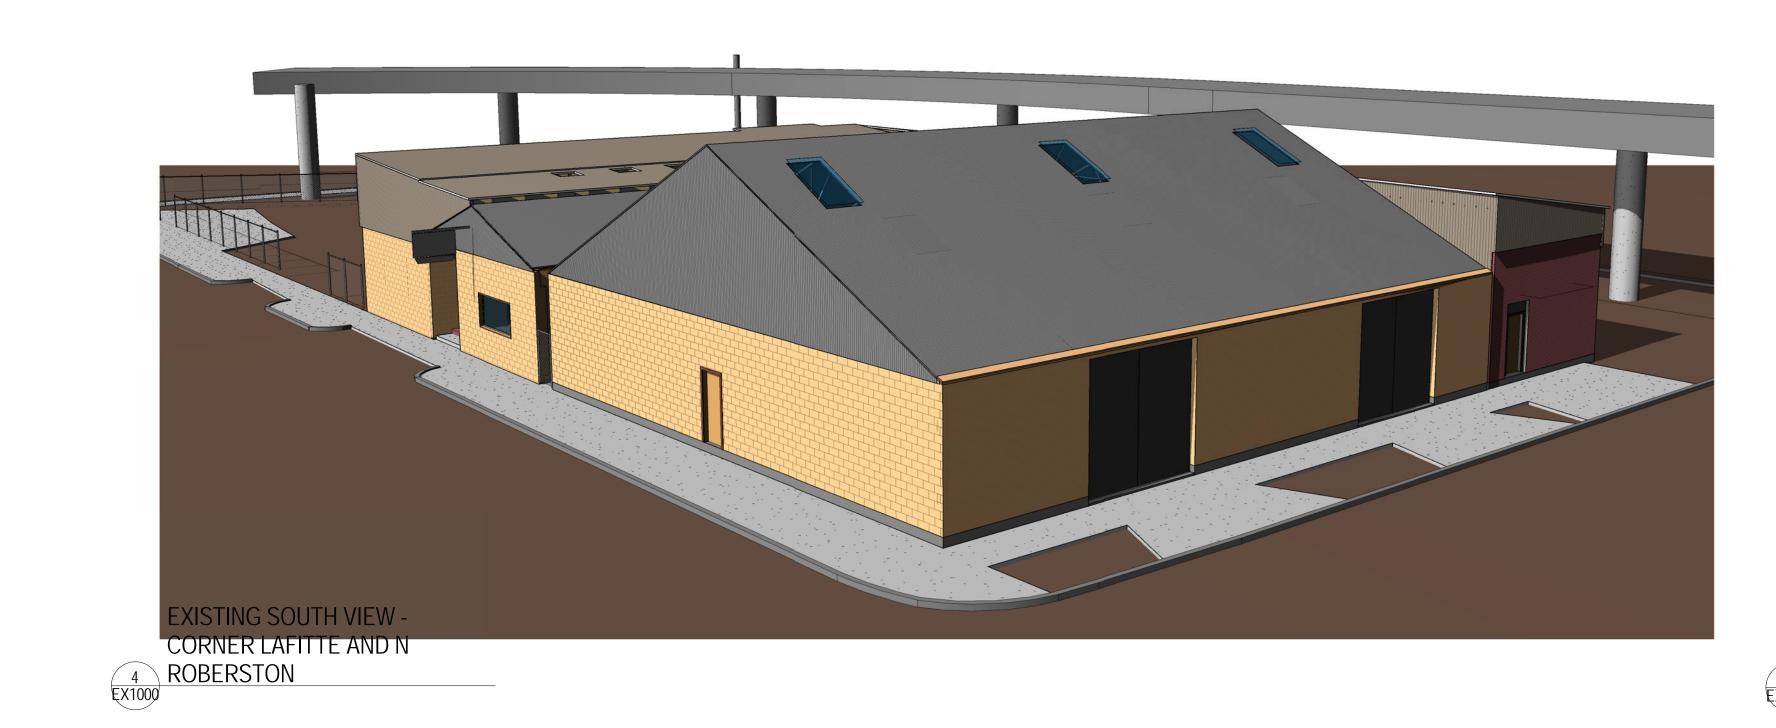
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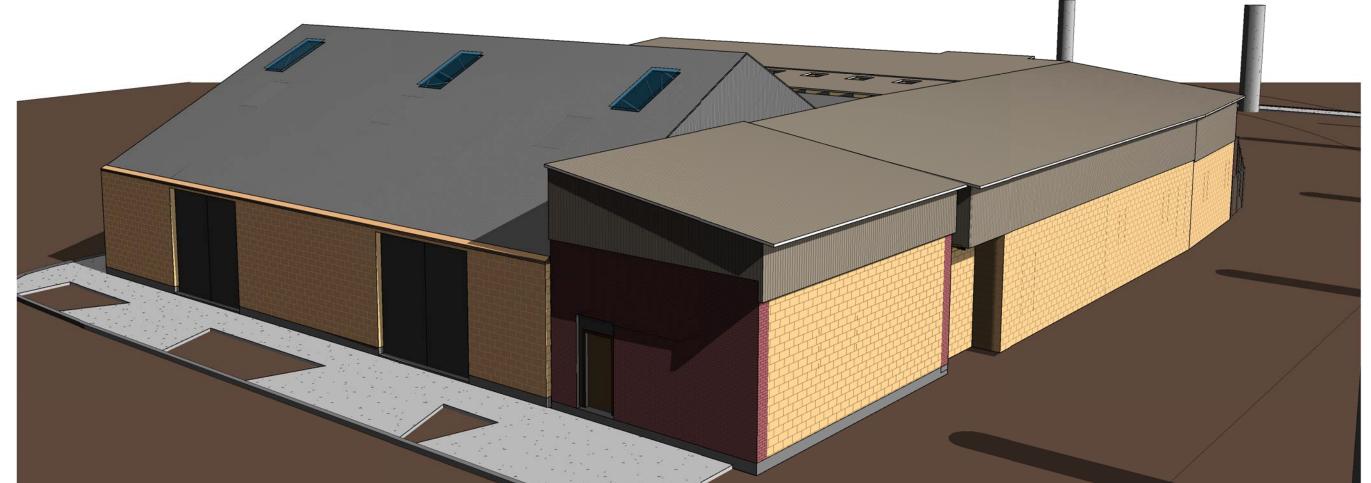












EXISTING SOUTHEAST VIEW - N 5 ROBERSTON ST EX1000

EXISTING SOUTHWEST VIEW -6 LAFITTE AVE

